


TYPICAL SECTION

SCALE: 1/2" = 1'-0"


SWALE (A)

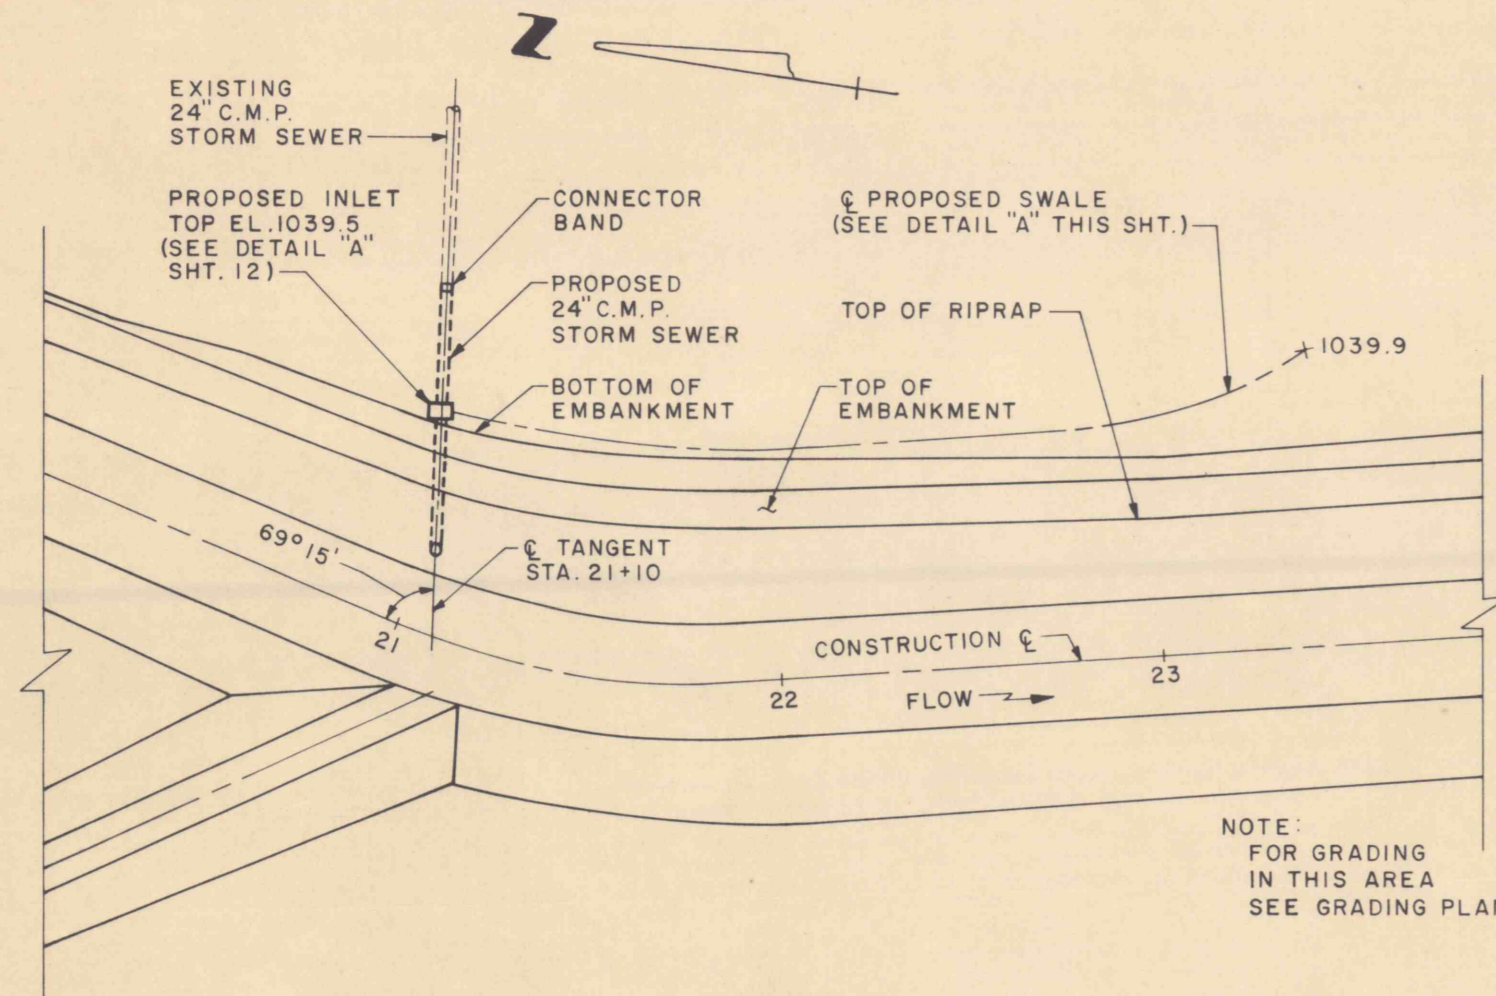

PLAN


SCALE: 1" = 50'

NOTE:  
FOR GRADING  
IN THIS AREA  
SEE GRADING PLAN

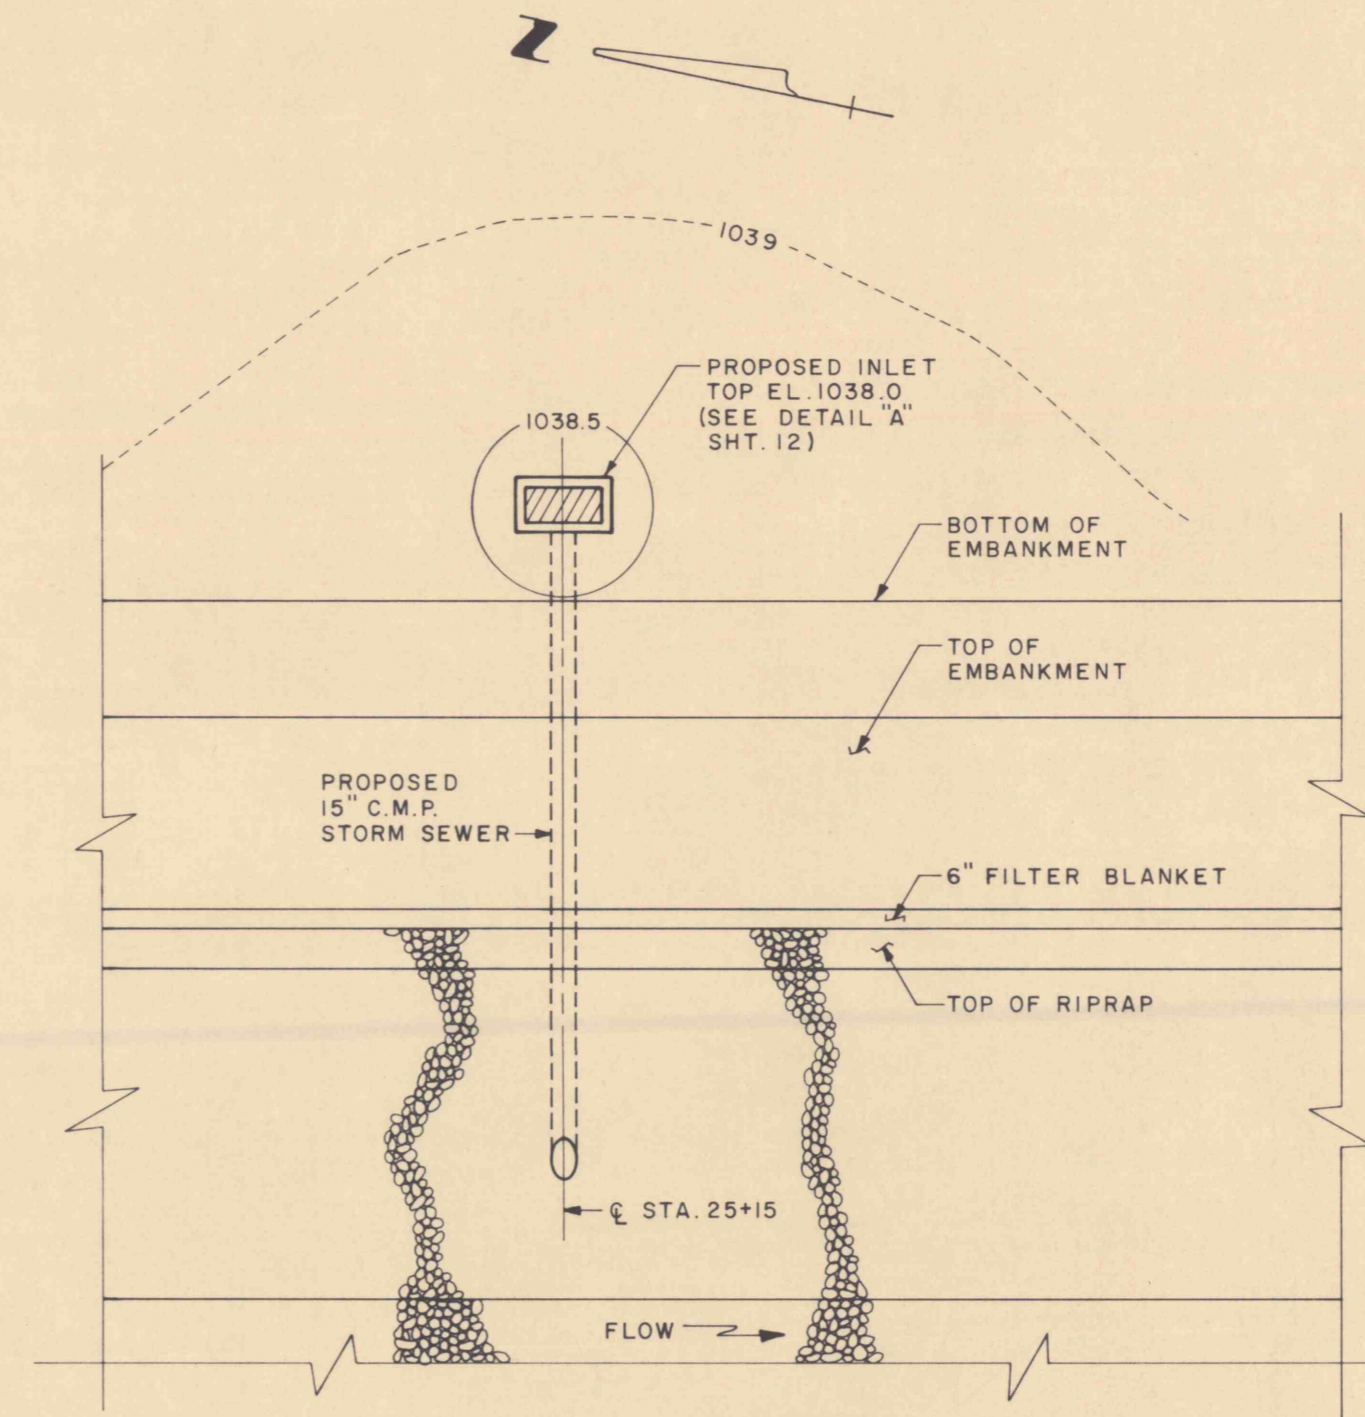

PLAN


SCALE: 1" = 10'

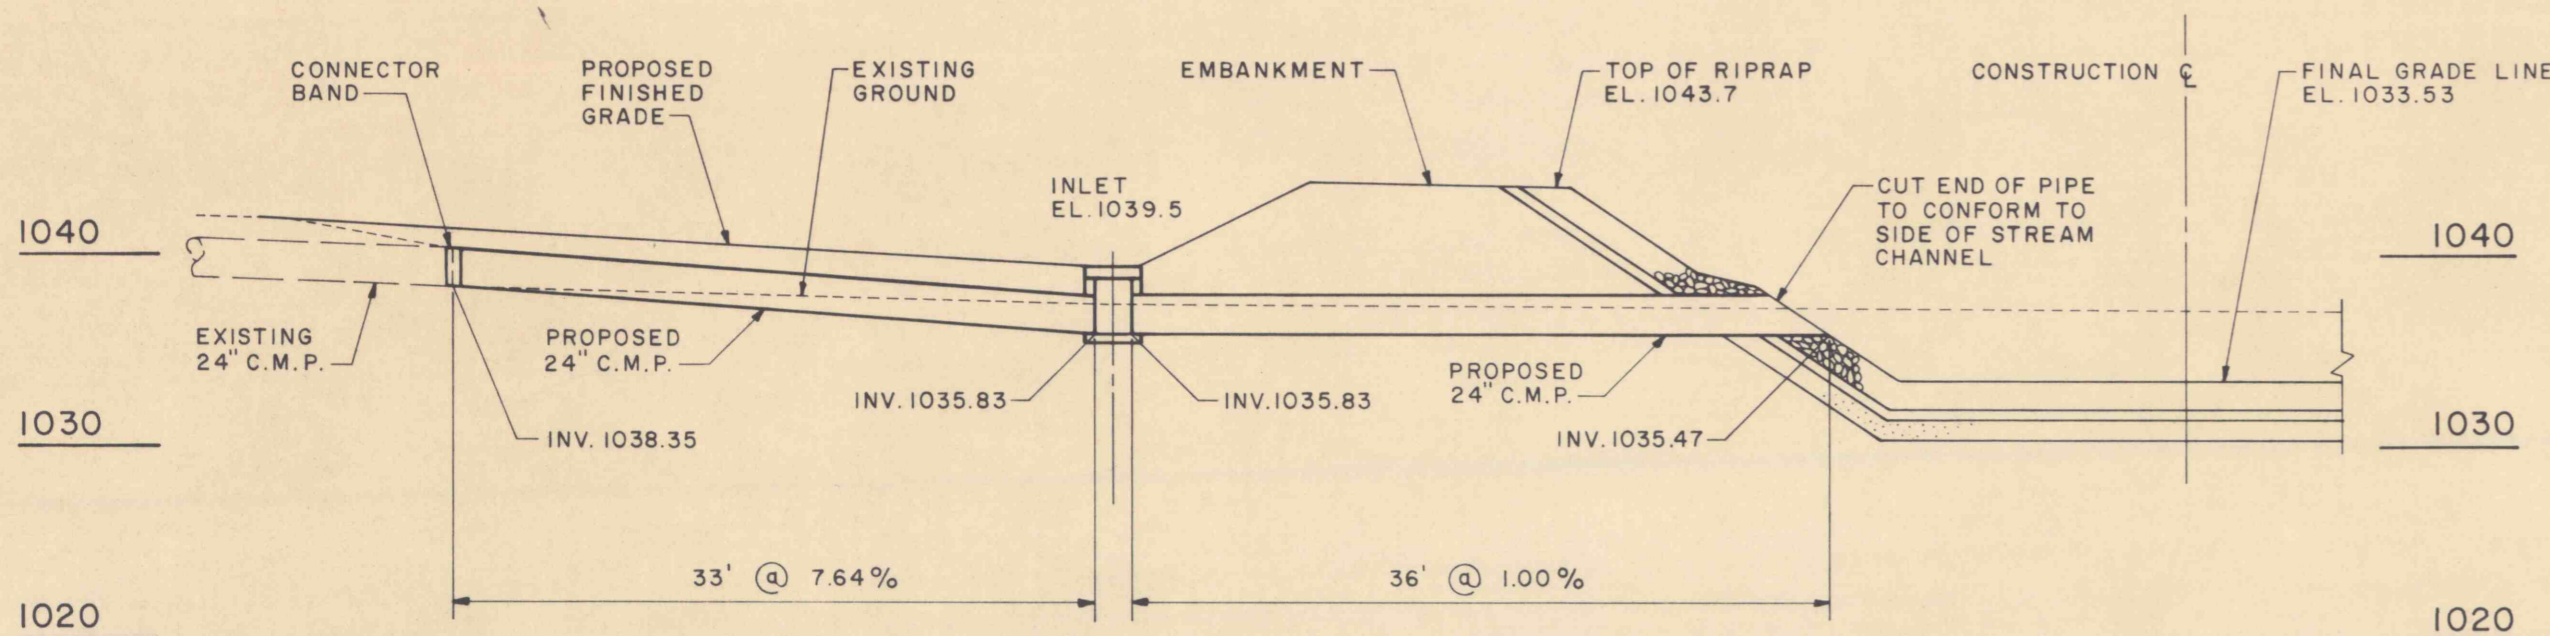

SECTIONAL ELEVATION

SCALE: HOR. 1" = 10'  
VERT. 1" = 10'

STORM SEWER CONNECTION STA. 21+10 (B)

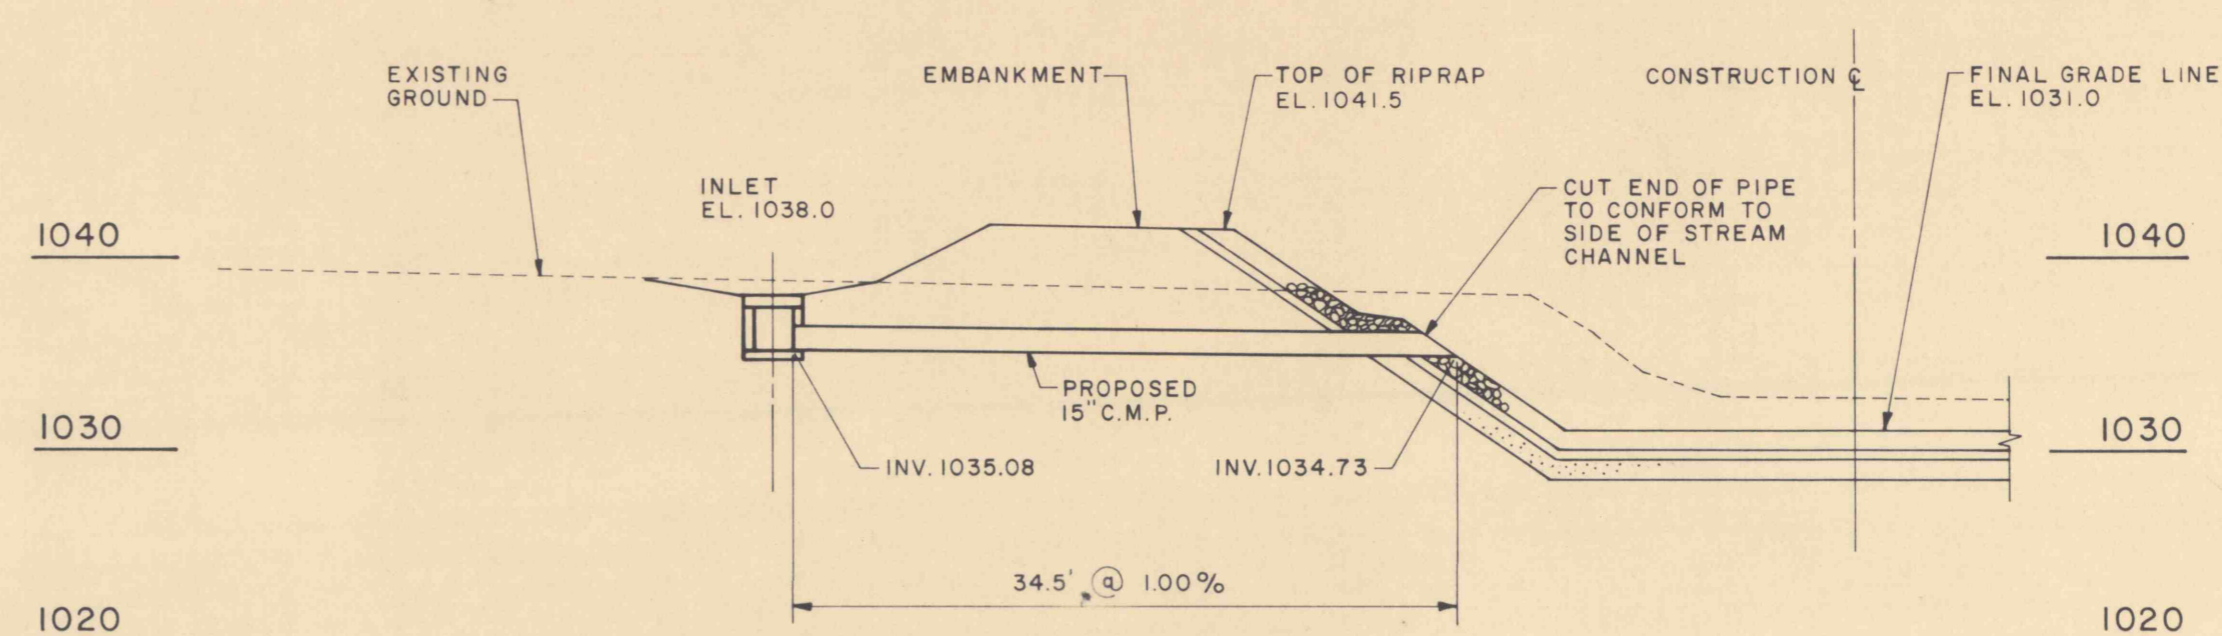

SECTIONAL ELEVATION

SCALE: HOR. 1" = 10'  
VERT. 1" = 10'

STORM SEWER CONNECTION STA. 25+15 (C)

NO.	DATE	REVISION	APPR.

SUBMITTED	
PROFESSIONAL	
APPROVED	
CHIEF - DIVISION OF SORE RECLAMATION	
APPROVED	
DIRECTOR - BUREAU OF DESIGN	

REGISTERED PROFESSIONAL ENGINEER	
DATE	

COMMONWEALTH OF PENNSYLVANIA  
DEPARTMENT OF ENVIRONMENTAL RESOURCES  
OFFICE OF RESOURCES MANAGEMENT  
**CONTRACT NO. SL 139-1-6-101.1**  
**MINE DRAINAGE POLLUTION ABATEMENT**  
**FALL BROOK**  
**LACKAWANNA RIVER WATERSHED**  
**LACKAWANNA COUNTY**  
**PENNSYLVANIA**

GANNETT FLEMING CORDDRY AND CARPENTER, INC.  
Consulting Engineers  
P.O. BOX 1963 HARRISBURG, PA

MISCELLANEOUS  
DETAILS

DRAWN BY T.A.S.	DATE MAY, 1977	DRAWING NO. 11 of 12
CHECKED BY D.J.B.	SCALE AS SHOWN	