





SCALE 1/2"=1'-0"

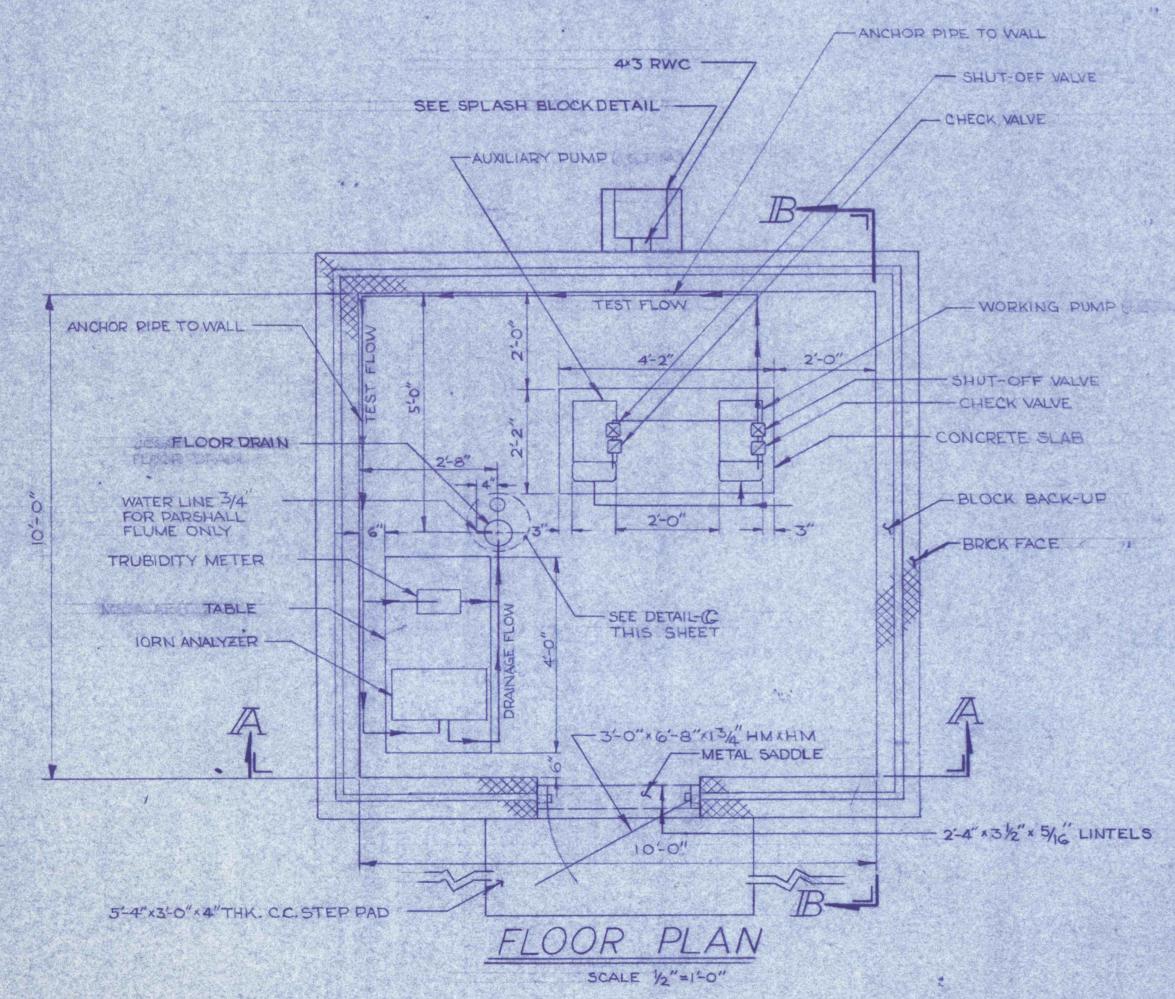


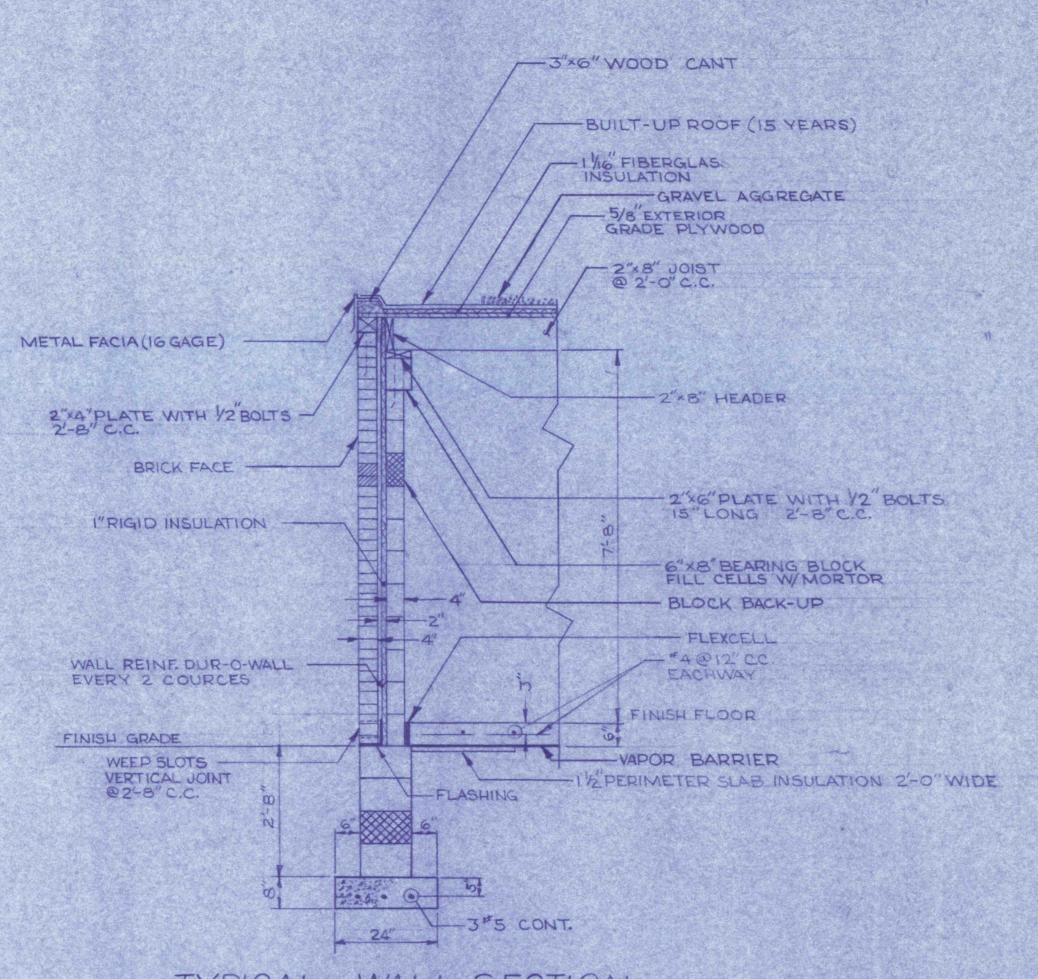


TYPICAL WALL SECTION SCALE 1/2"=1'-0"

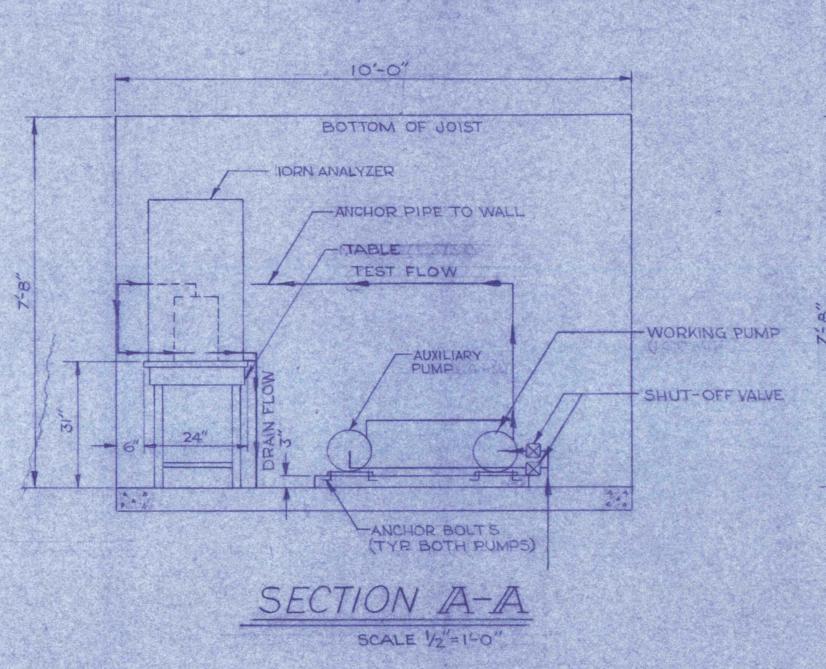

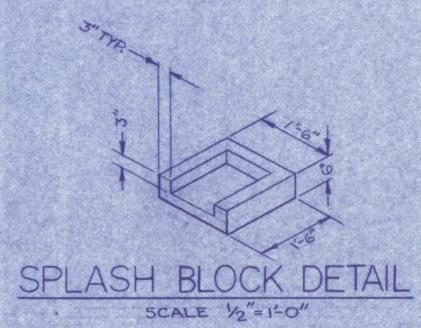

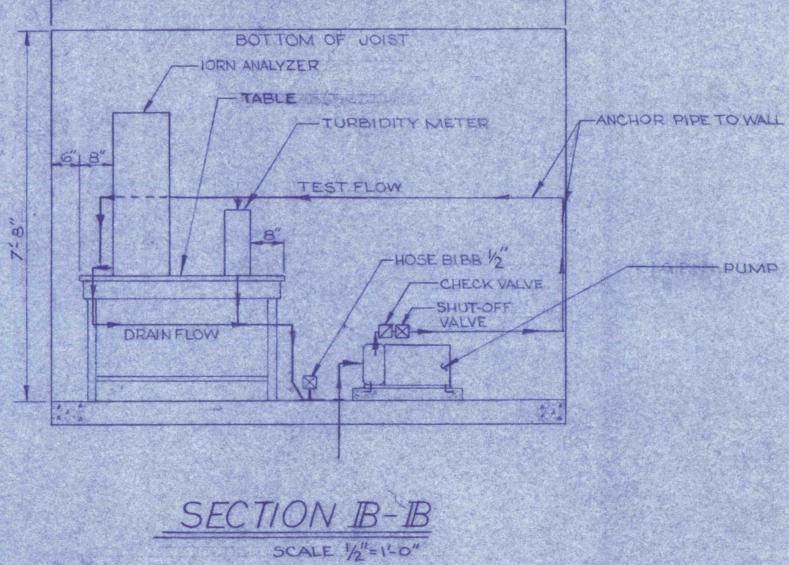

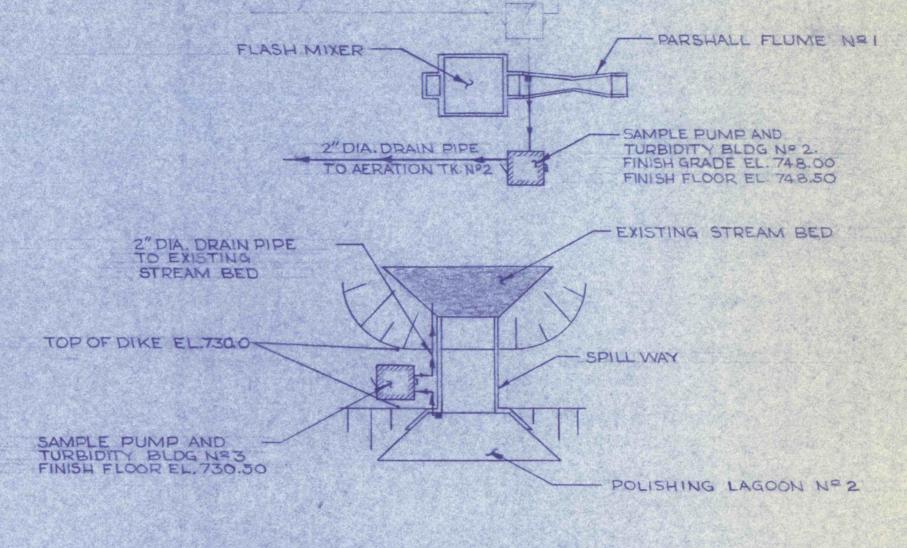


LOCATION PLAN SCALE 1"=30-0"


GENERAL NOTES:

- 1. SEE DWG. Nº FOR ELEVATION VIEWS OF THIS BUILDING. 2. ALL PIPES & FITTINGS 12" DIA. UNLESS OTHERWISE SPECIFIED.
- 3. ALL PIPES FOR BUILDING Nº 2 TO BE STAINLESS STEEL. 4. ANCHOR ALL PIPES TO WALLS.
- 5. SUB-SOIL MUST BE UNIFORMLY WELL COMPACTED. A 6" BASE COURSE OF WELL COMPACTED STONE OR GRAVEL MUST BE
- PROVIDED BEFORE THE SLAB IS POURED.
- 6. DRAIN TO ROTATE TO SUIT DRAINAGE AREA
- 7. ALL PIPES ENTERING LEAVING BUILDING MUST BE UNDER

-HOSE BIBB 1/2" - 2"DRAIN PIPE - FLOOR DRAIN . DETAIL-C SCALE 1/2"=1-0" SEE NOTE 6 \$7

PRE-FINAL

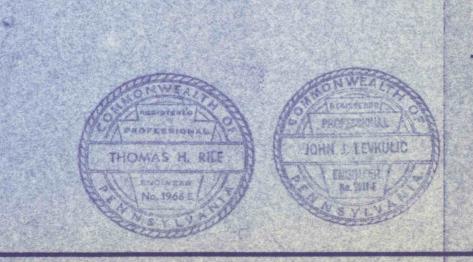

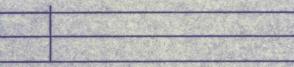

SAMPLE PUMP BUILDING NO. 2&3

CONSTRUCTION OF TREATMENT FACILITIES
FOR ACID MINE DRAINAGE
RAUSCH CREEK WATERSHED SCHUYLKILL COUNTY, PENNSYLVANIA

ANTHRACITE RESEARCH & DEVELOPMENT CO. INC.

STANPAT PRODUCTS INC. PORT WASHINGTON, N.

JOB NO: 6805
DATE: NOV. 1969
SCALE: AS NOTED
DRAWN: RM. WALTON

APPROVED: THE JUL