


PLAN CHANNELS "O" AND "P"  
Scale: 1 in. = 100 ft.

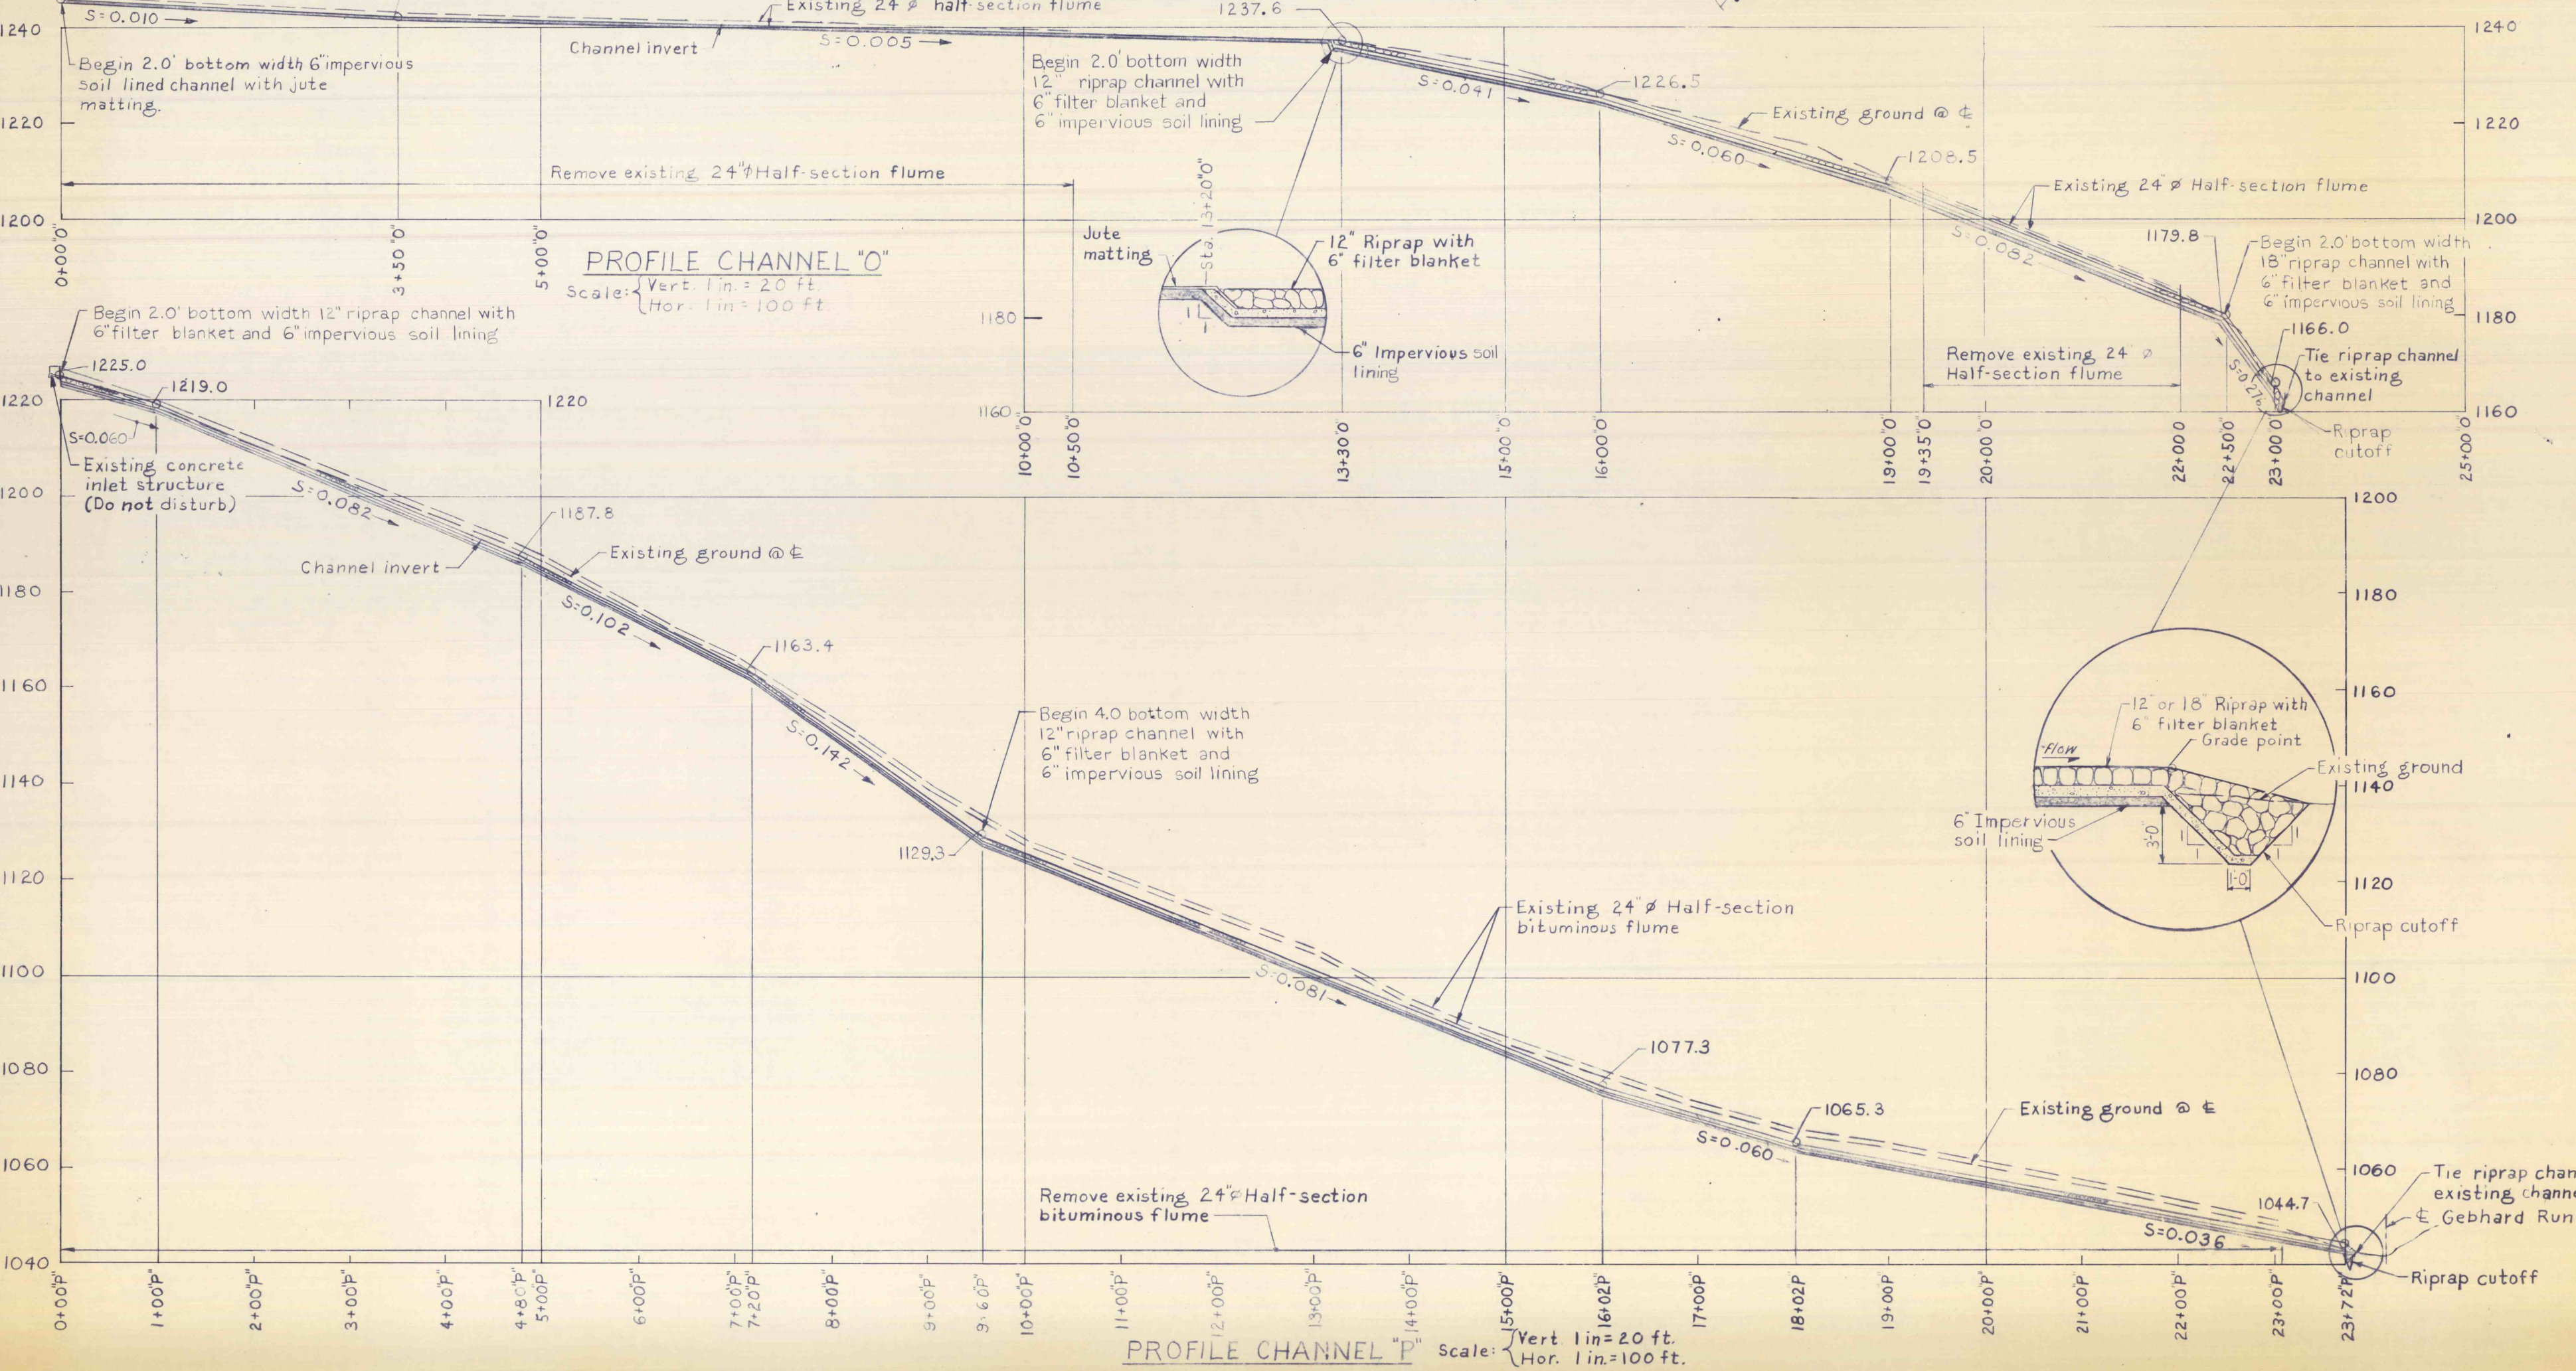

PROFILE CHANNEL "O"  
Scale: Vert. 1 in. = 20 ft.  
Hor. 1 in. = 100 ft.

PROFILE CHANNEL "P"  
Scale: Vert. 1 in. = 20 ft.  
Hor. 1 in. = 100 ft.

- NOTES:
1. For General Notes, see Dwg. No. 2
  2. For detailed limits of access to the site, see Dwg. No. 2

- REFERENCES:
1. Cross Sections ----- Dwg. No. 7.

NO.	DATE	REVISION	APPR.
SUBMITTED <i>M. Rae</i> PROJECT CO-ORDINATOR			
APPROVED <i>Albert A. Ramani</i> CHIEF-DIVISION OF MINE RECLAMATION			
APPROVED <i>Don Perry</i> DIRECTOR-BUREAU OF DESIGN			
COMMONWEALTH OF PENNSYLVANIA DEPARTMENT OF ENVIRONMENTAL RESOURCES OFFICE OF RESOURCES MANAGEMENT			
CONTRACT NO. SL 126-2-7/9 F			
MINE DRAINAGE POLLUTION ABATEMENT REMEDIAL WORK SWATARA CREEK WATERSHED			
REILLY TOWNSHIP		SCHUYLKILL CO., PA.	
<b>CHANNELS "O" AND "P" PLAN AND PROFILES</b>			
DRAWN BY <i>m.m.c.</i>	DATE 25 May 78	DRAWING NO.	
CHECKED BY <i>EGR</i>	SCALE As Shown	6 of 7	