

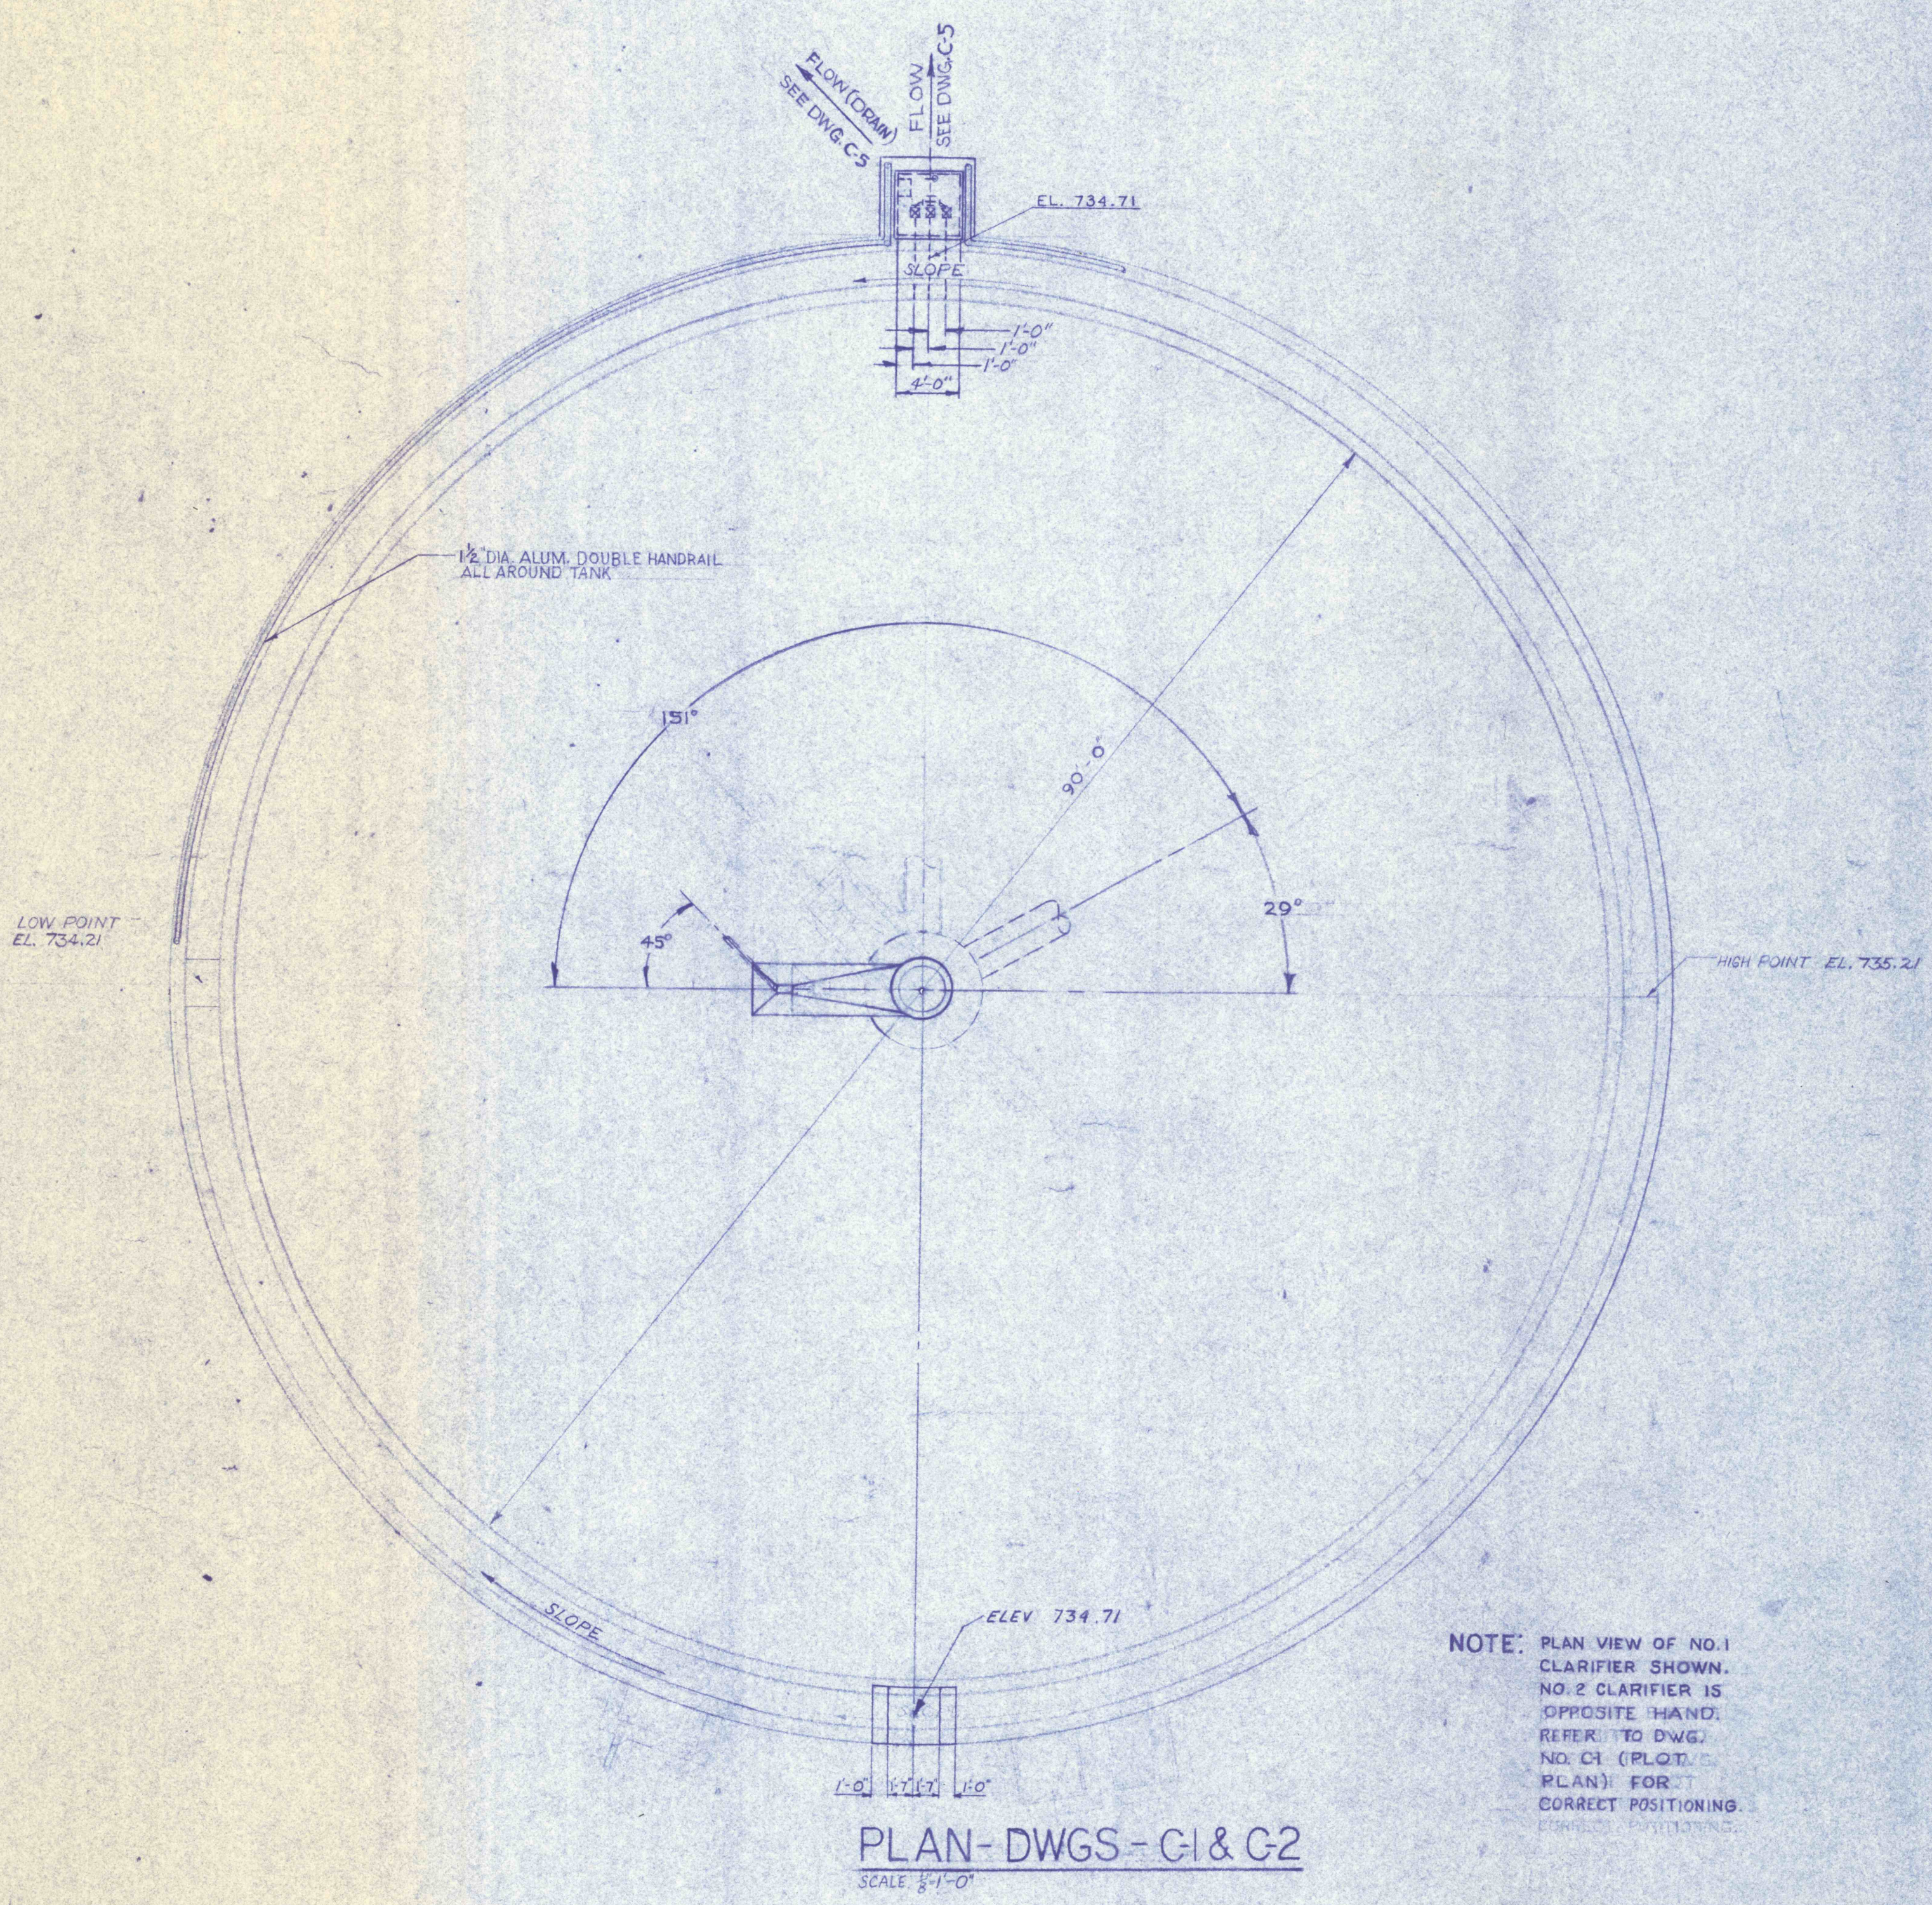


- GENERAL NOTES:**
1. WATER-TIGHT FLANGED SLEEVE FOR ALL PIPES THRU WALLS OR SLABS BELOW WATER LEVEL.
 2. REFER TO DWG. NO. C-17 FOR CLARIFIERS MECHANICAL DETAILS.
 3. CONTINUOUS WATER STOP TO BE PLACED AT ALL CONSTRUCTION JOINTS.
 4. SUB SOIL MUST BE UNIFORMLY WELL COMPACTED. A 12" BASE COURSE OF WELL COMPACTED CRUSHED STONE OR GRANULE MUST BE PROVIDED BEFORE THE SLAB IS POURED.

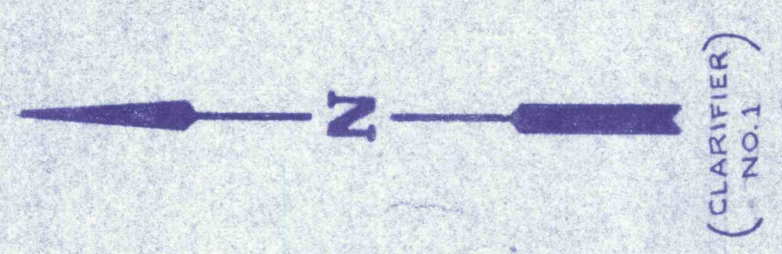

NOTE: PLAN VIEW OF NO. 1 CLARIFIER SHOWN. NO. 2 CLARIFIER IS OPPOSITE HAND. REFER TO DWG. NO. C1 (PLOT PLAN) FOR CORRECT POSITIONING.

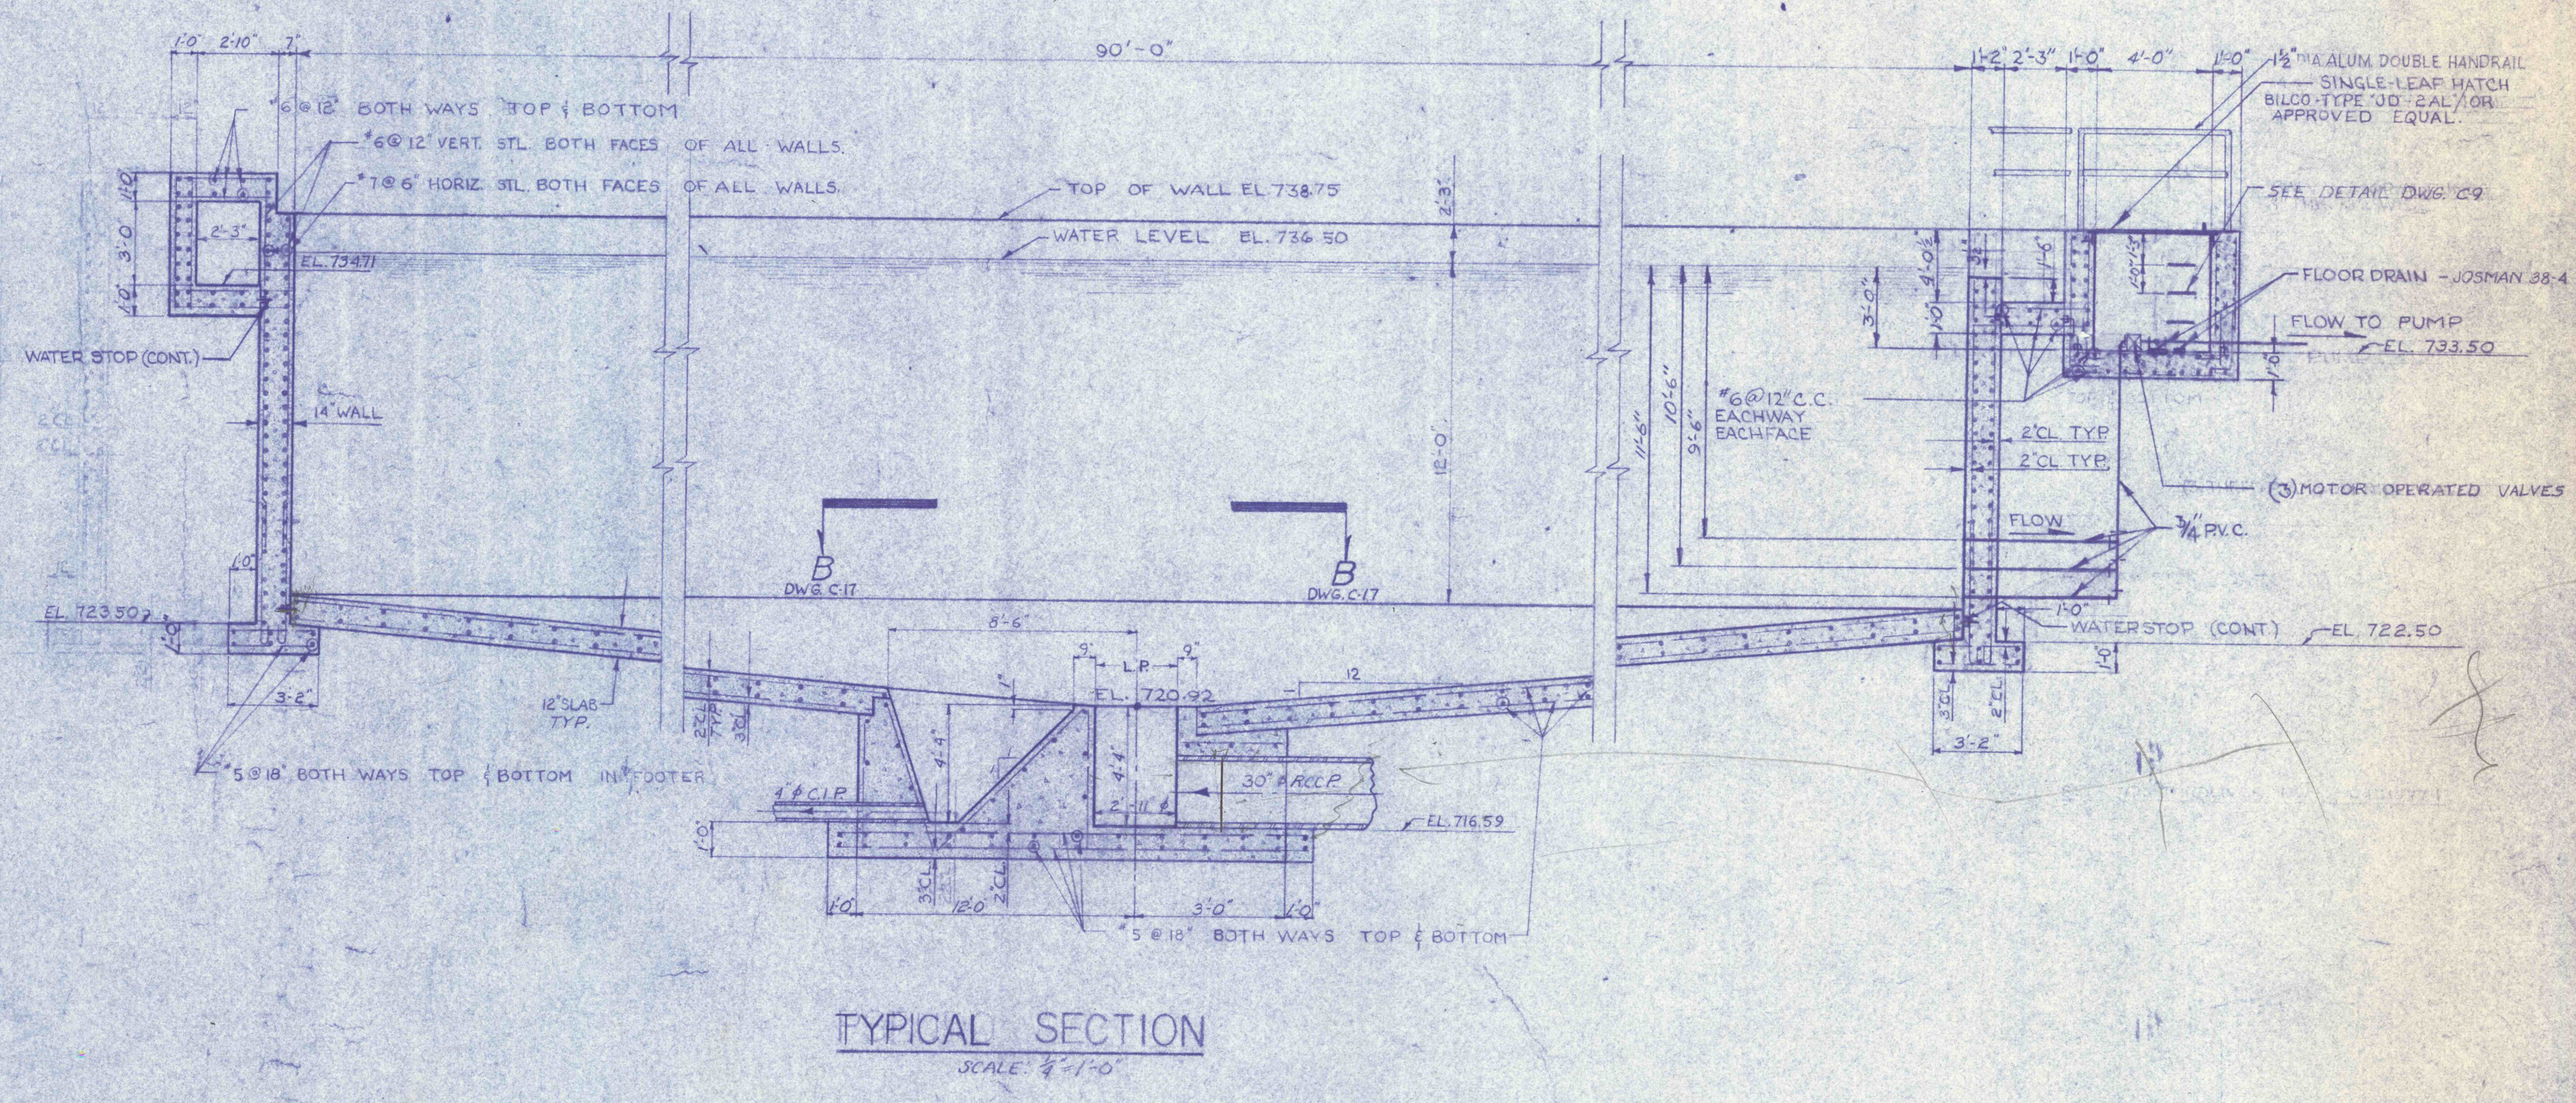

REVISIONS	
TYPICAL CLARIFIER - STRUCTURAL	
CONSTRUCTION OF TREATMENT FACILITIES FOR ACID MINE DRAINAGE	
RAUSCH CREEK WATERSHED	
SCHUYLKILL COUNTY, PENNSYLVANIA	
ANTHRACITE RESEARCH & DEVELOPMENT CO. INC. consulting engineers	
POTTSVILLE PENNSYLVANIA TAMAGUA	
JOB NO. 6802 DATE: NOV 1969 SCALE: AS NOTED DRAWN: S. J. LEVIGAN APPROVED:	DRAWING NO. C-16