




**GROUND FLOOR PLAN**  
SCALE: 1/2" = 1'-0"

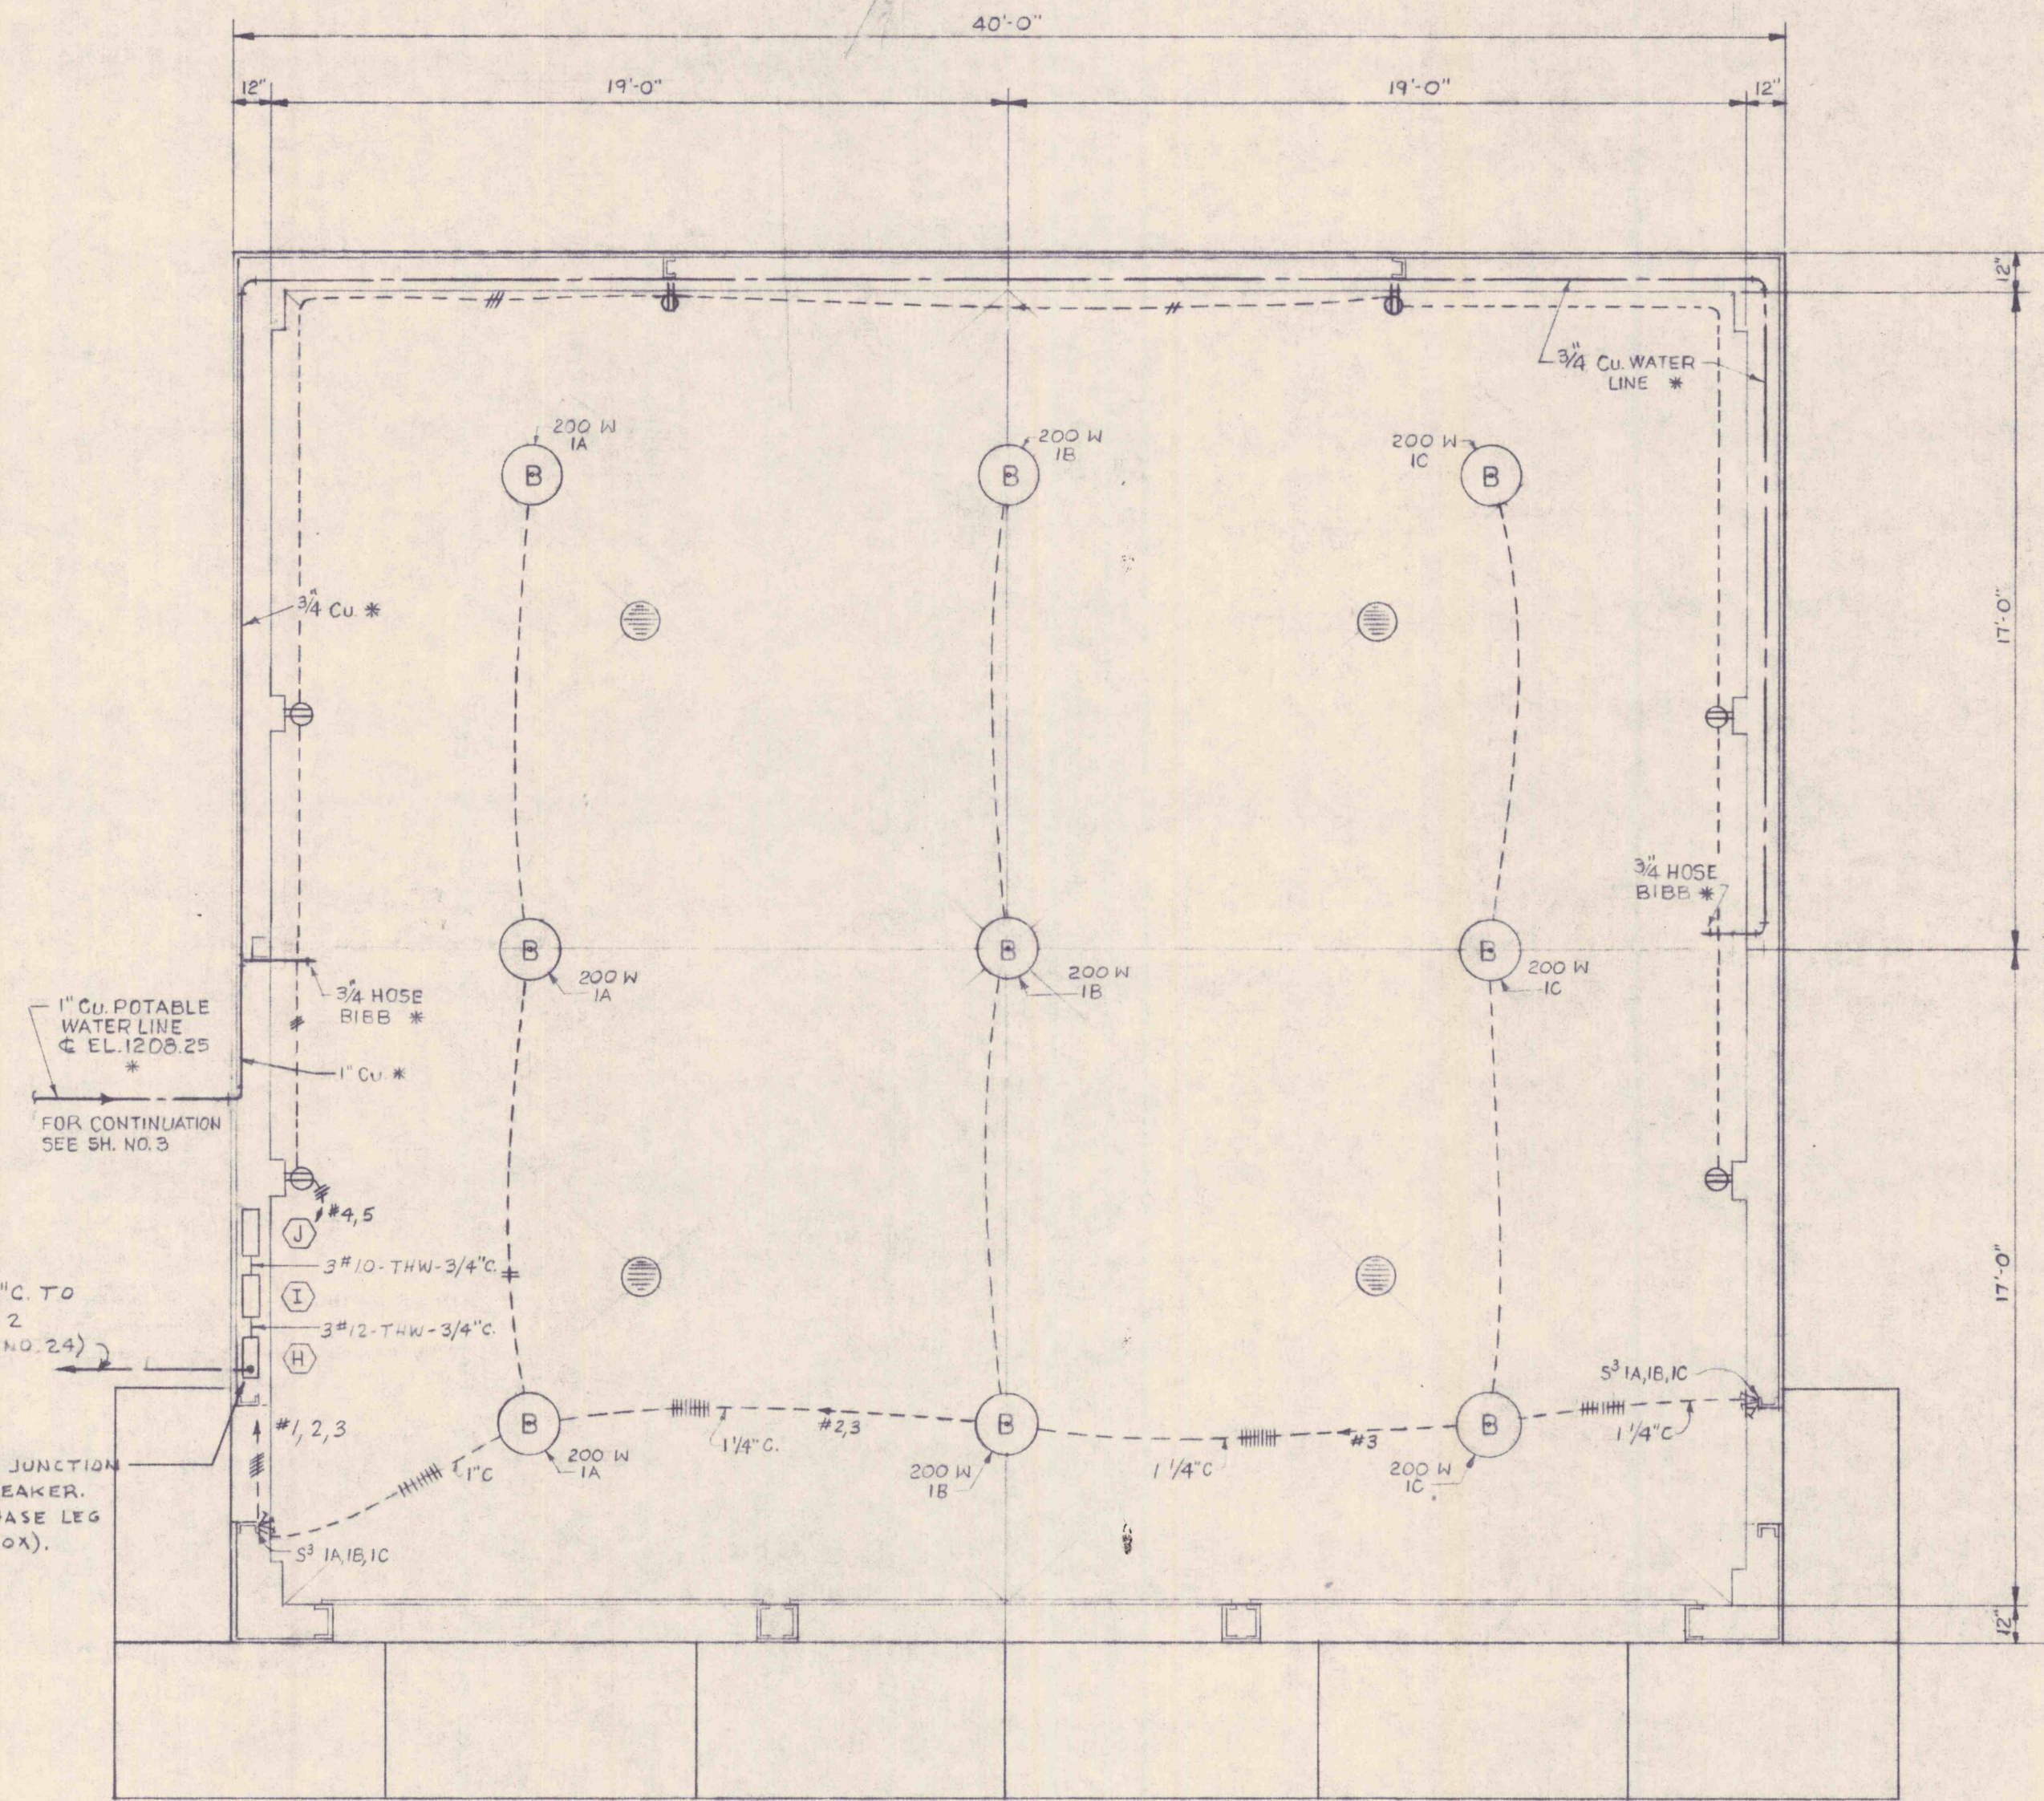

**GARAGE FOUNDATION PLAN**  
SCALE: 1/4" = 1'-0"

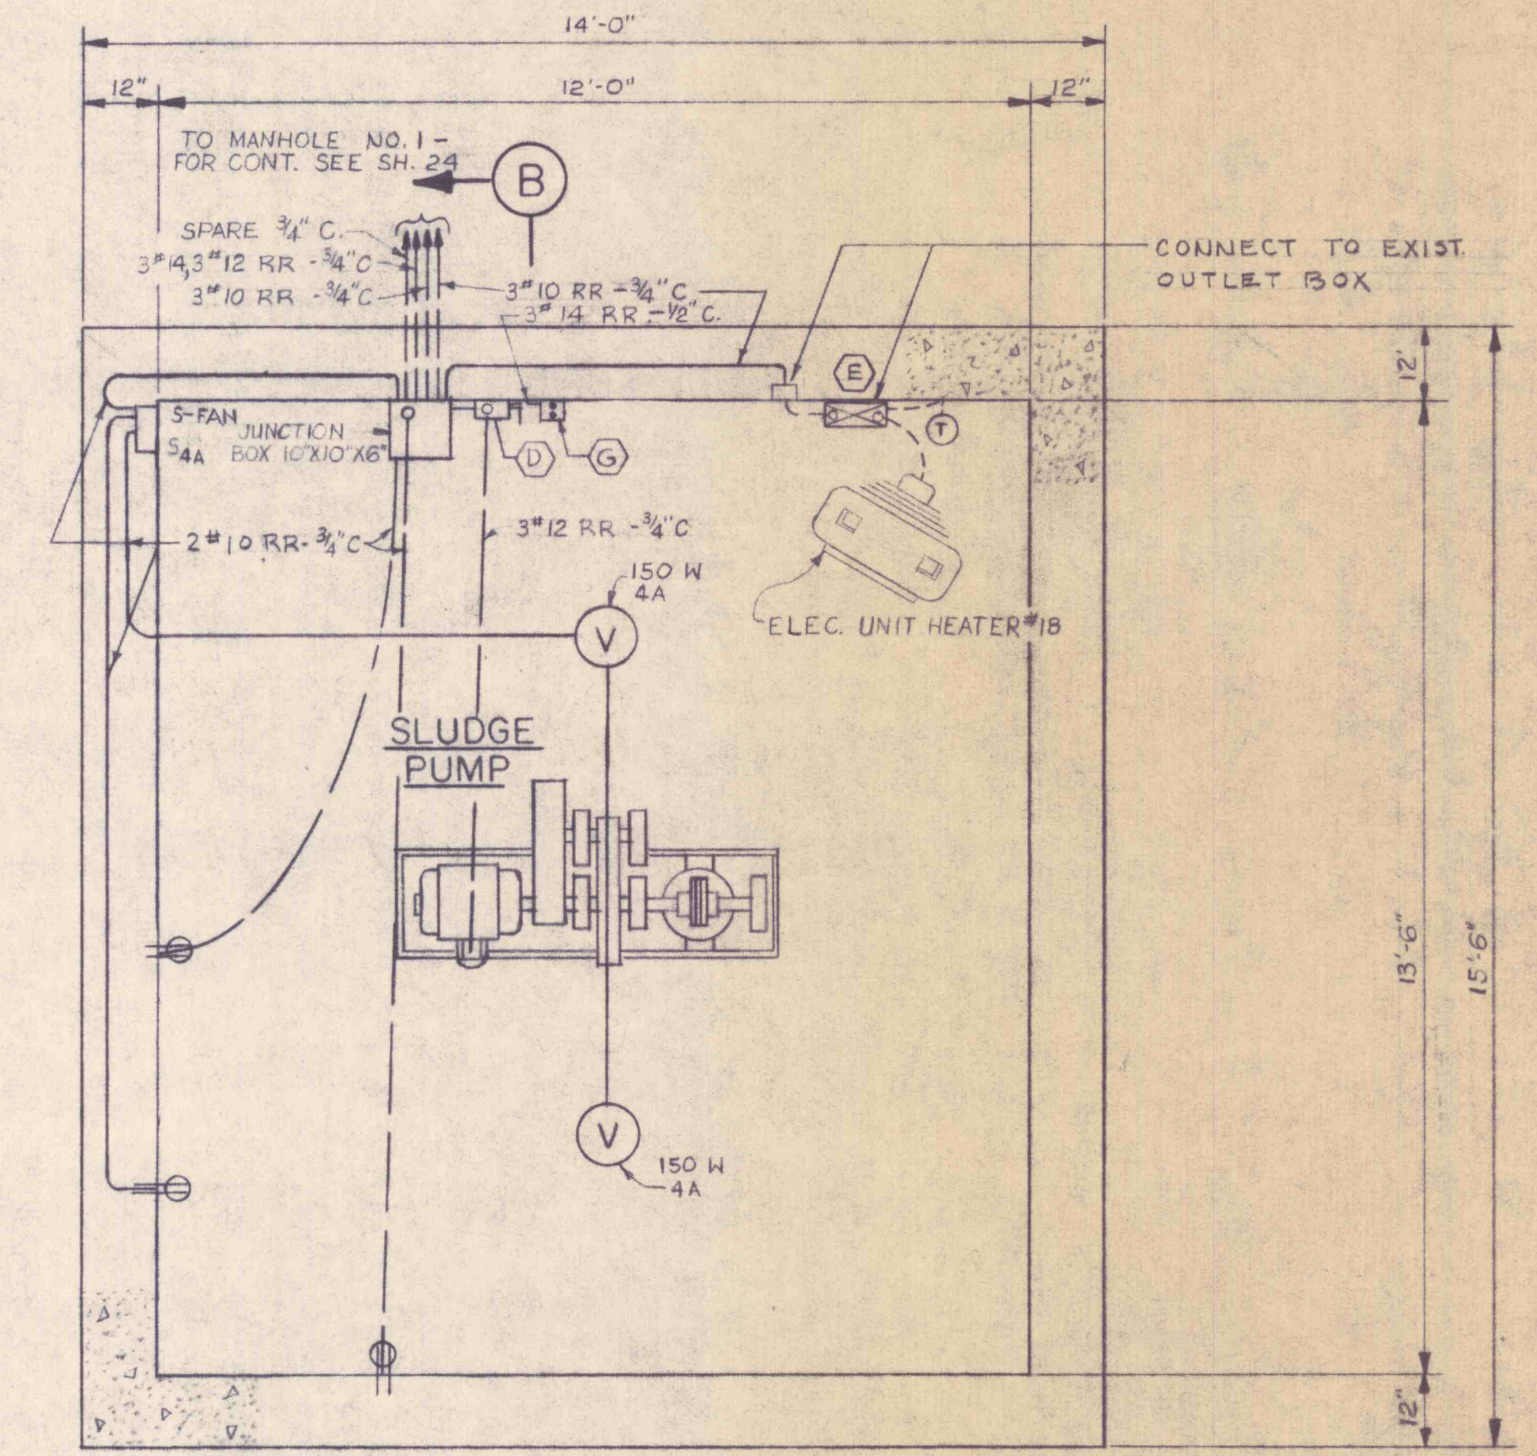


**BASMENT PLAN**  
SCALE: 3/8" = 1'-0"

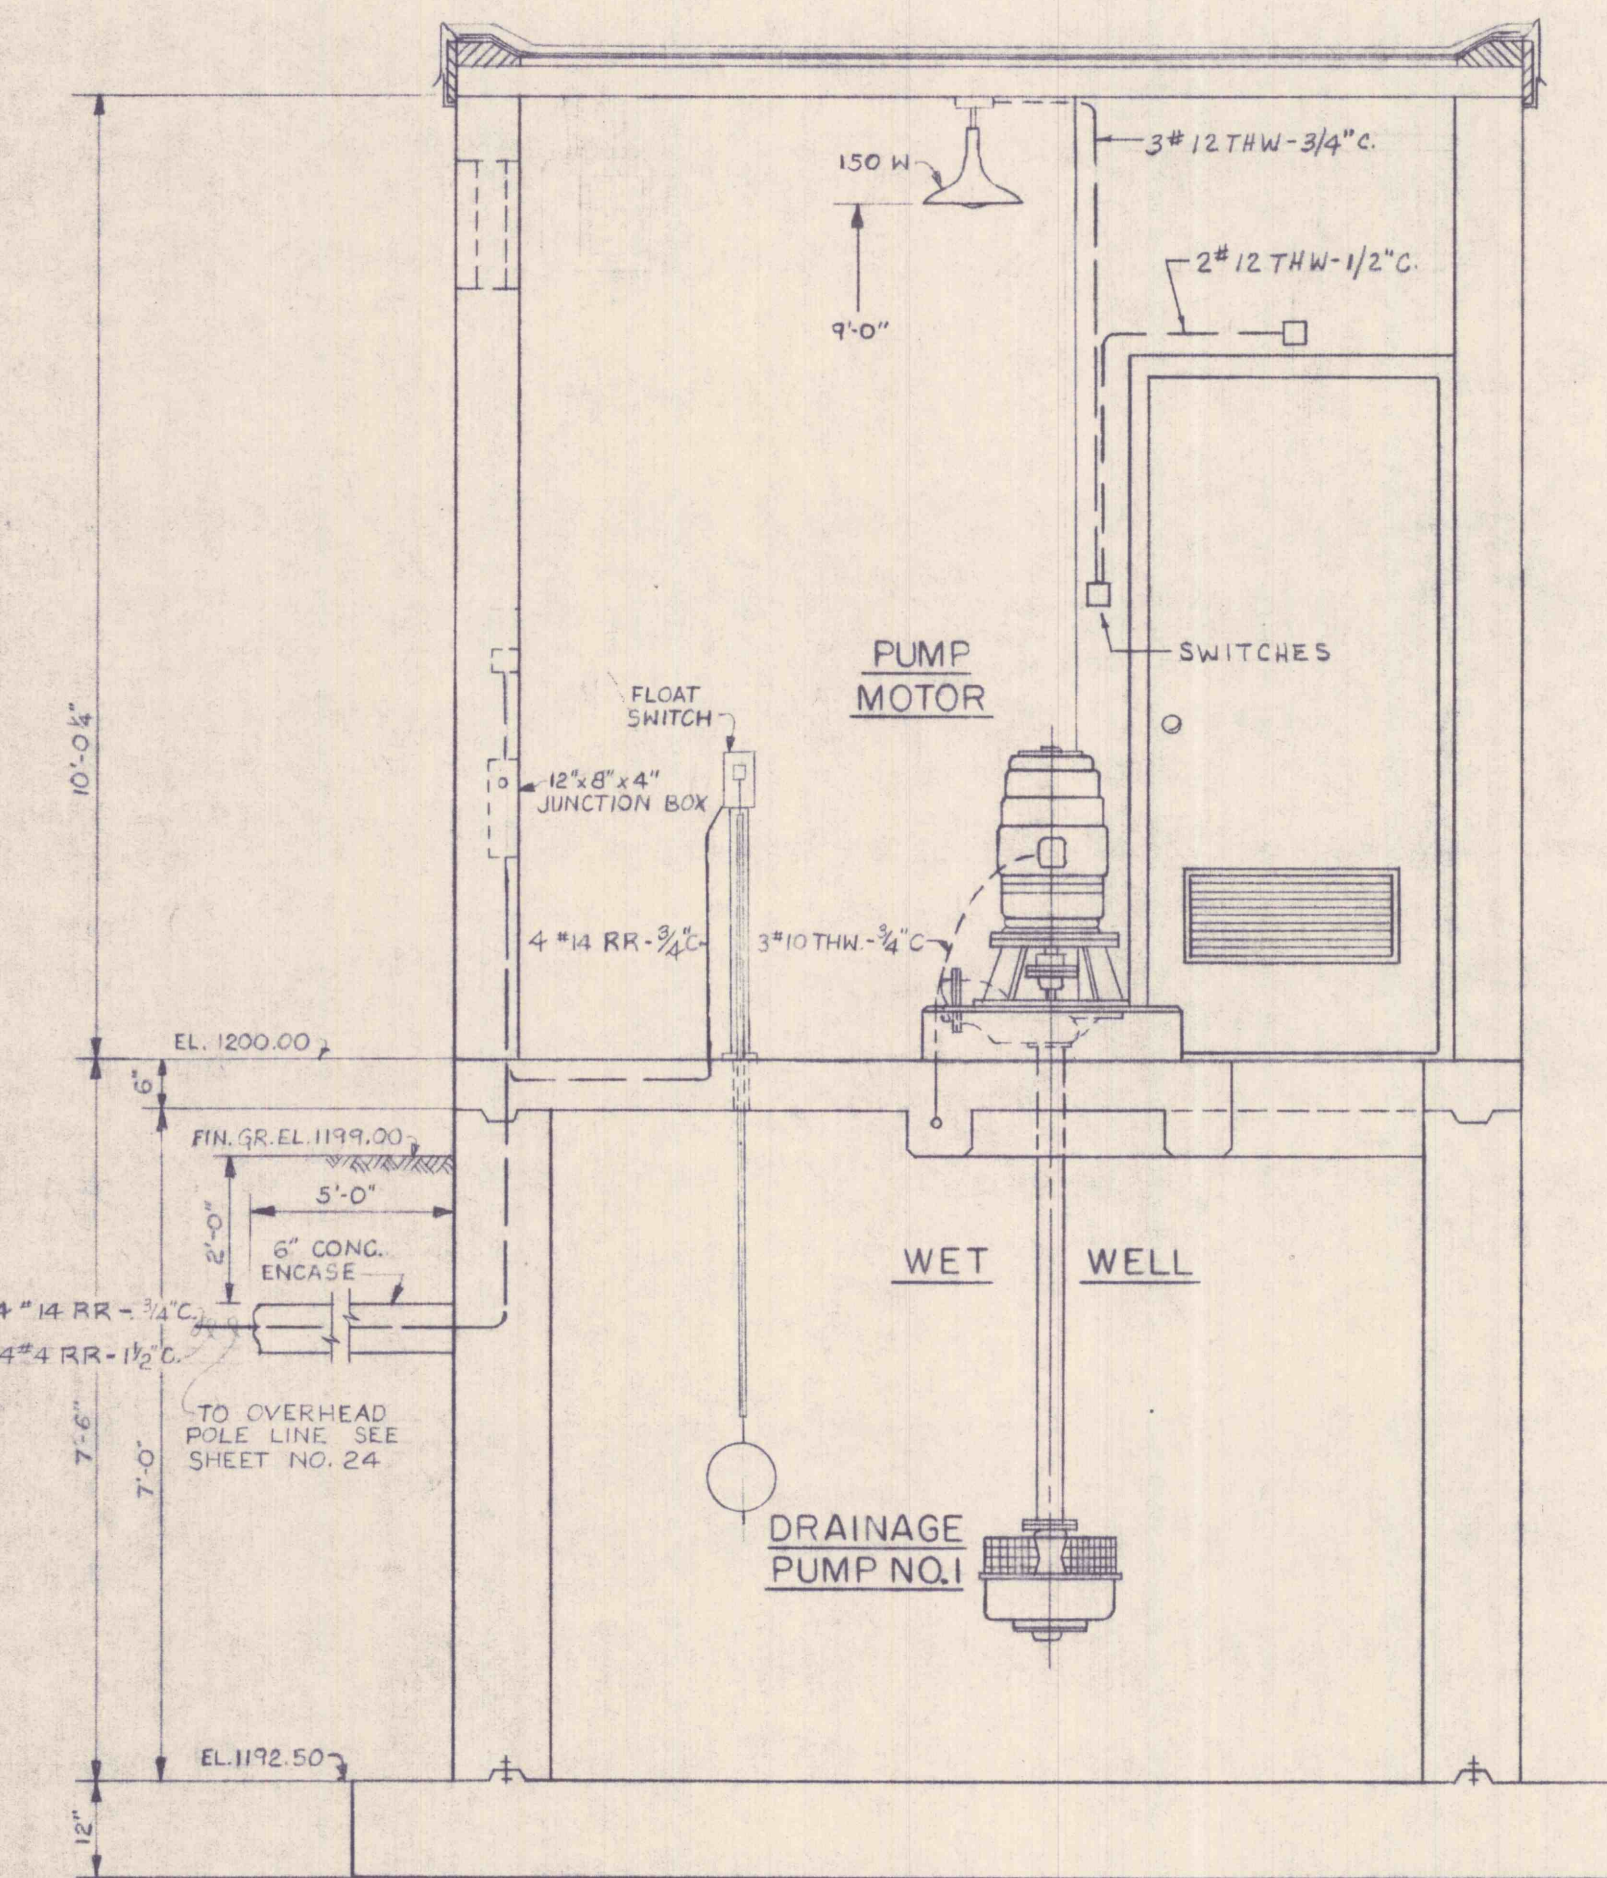


**SECTION A-A**  
SCALE: 1/2" = 1'-0"

**PROCTOR NO. 1 PUMPING STATION**

**LEGEND**  
\* BY PLUMBING CONTRACTOR

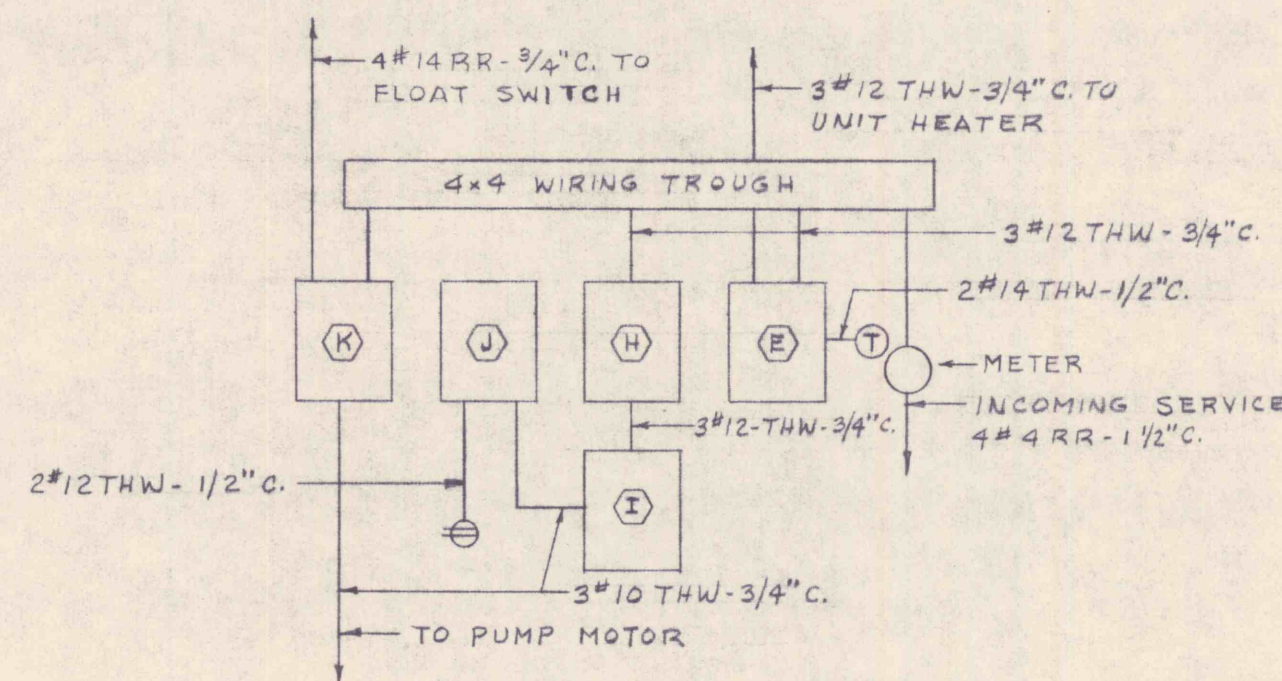


**ELECTRIC DISTRIBUTION DIAGRAM**  
**PROCTOR NO. 1 PUMPING STATION**  
NO SCALE

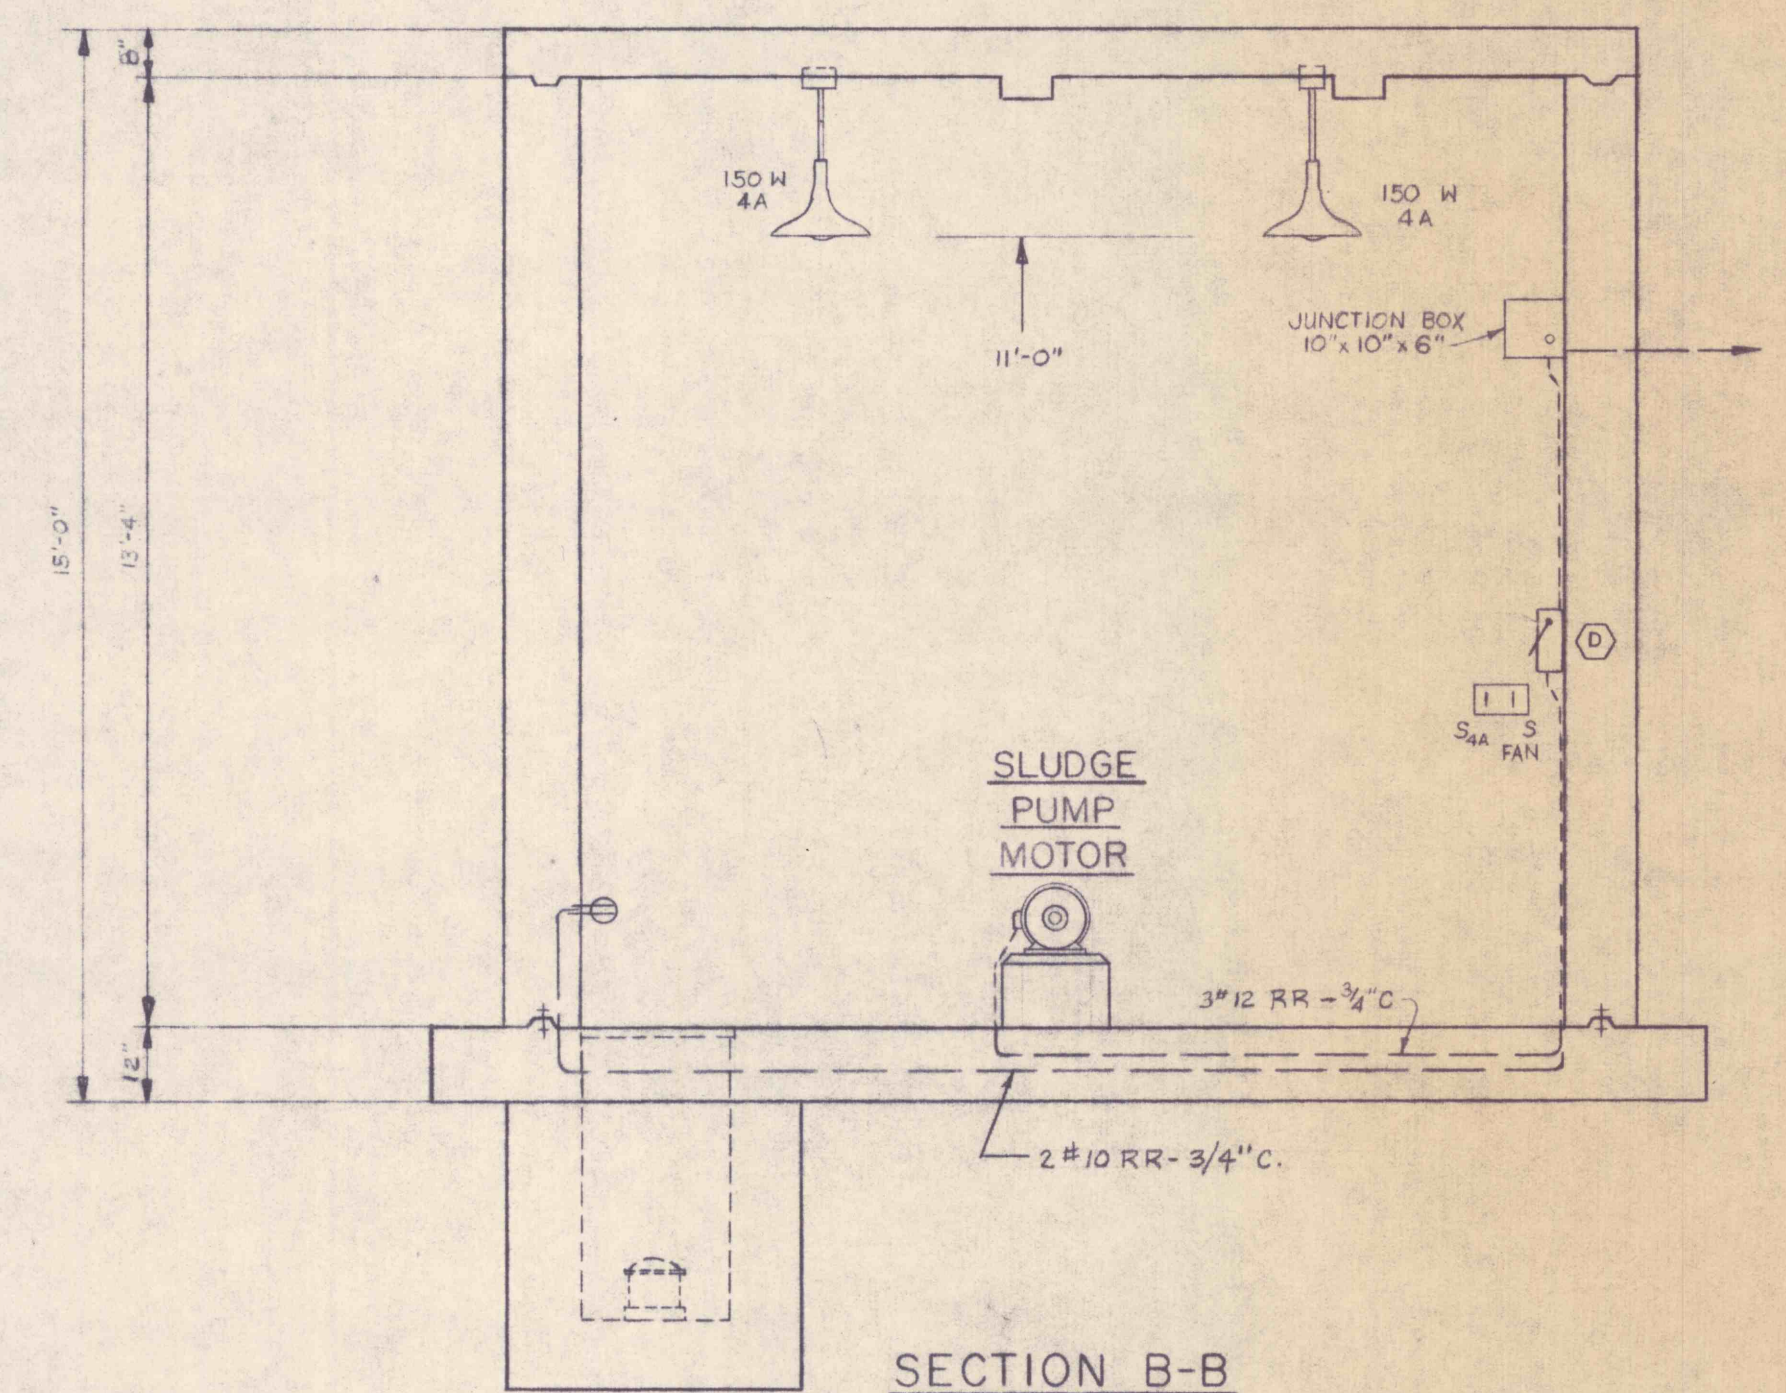

**SECTION B-B**  
SCALE: 3/8" = 1'-0"

**SLUDGE PUMPING STATION**

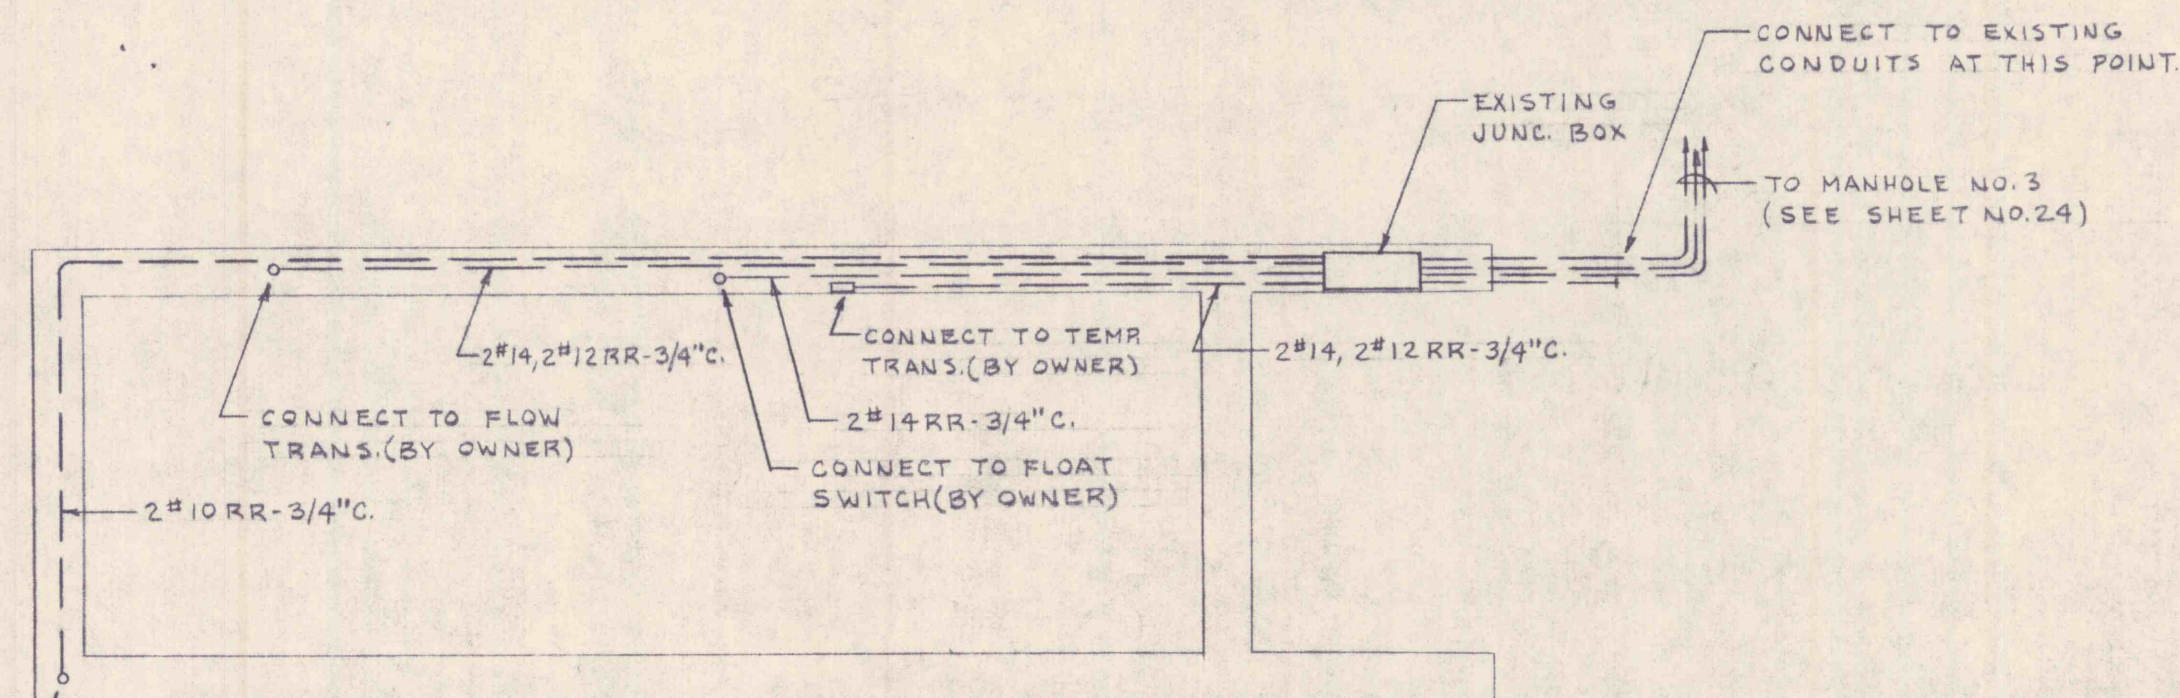

**PLANT WATER SUMP PLAN**  
NO SCALE

REVISIONS			
NO.	DESCRIPTION	DATE	BY



DRAWN E.M.M. TRACED W.P.H. CHECKED C.K.M. APPROVED G.S.B. APPROVED	<b>GANNETT FLEMING CORDDRY &amp; CARPENTER, INC.</b> <b>ENGINEERS</b> 600 N. SECOND ST. HARRISBURG, PENNA.	JOB No. <b>4590</b>	THE PENNSYLVANIA STATE UNIVERSITY CONSTRUCTION OF A MINE DRAINAGE TREATMENT PLANT HUSTON TOWNSHIP, CLEARFIELD CO., PA.	SHEET No. <b>27</b>
		SCALE AS SHOWN		DRAWING No. I-17536
		DATE JUNE 1967	<b>PROCTOR NO. 1, GARAGE &amp; SLUDGE PUMPING STATION ELECTRICAL</b>	